

Project Name: UNIVERSITY OF CALIFORNIA, MERCED
COB ROOMS 110 & 114 RENOVATIONS
Project No.: 907015

ADDENDUM NO. 3
to the
CONTRACT DOCUMENTS
August 22, 2012

- I. Bidder acknowledges that it is the Bidder's responsibility to ascertain whether any Addenda have been issued and if so, to obtain copies of such Addenda. Bidder therefore agrees to be bound by all Addenda that have been issued for this bid.

This Addendum forms a part of the Contract Documents and modifies the original Bidding Documents. The following changes, additions, or deletions shall be made to the following documents as indicated and all other Contract Documents shall remain the same.

- II. BIDDING/CONTRACT DOCUMENTS AND DIVISION 1 SPECIFICATIONS – VOLUME 1
NONE
- III. CLARIFICATIONS
NONE
- IV. SPECIFICATIONS
NONE
- V. DRAWING SHEETS - Replace the following sheets with the drawings attached to this Addenda.

A. RE-ISSUE THE FOLLOWING DRAWING SHEETS

See drawings for clouded and called out Addendum #3 changes.


1. A-071, COVER SHEET SYMBOLS NOTES AND SCHEDULE
2. A-271, NEW FLOOR PLANS & REFLECTED CEILING PLANS
3. A-272, NEW INTERIOR ELEVATIONS
4. A-272(a), NEW INTERIOR ELEVATIONS (BID ALTERNATE)
5. A-571, CLASSROOM REMODEL DETAILS

UNIVERSITY OF CALIFORNIA, MERCED


By: University of California, Merced
University's Representative

Wenbo Yuan
Sr. Project Director


End of Addendum No. 3
ADDENDUM NO. 3

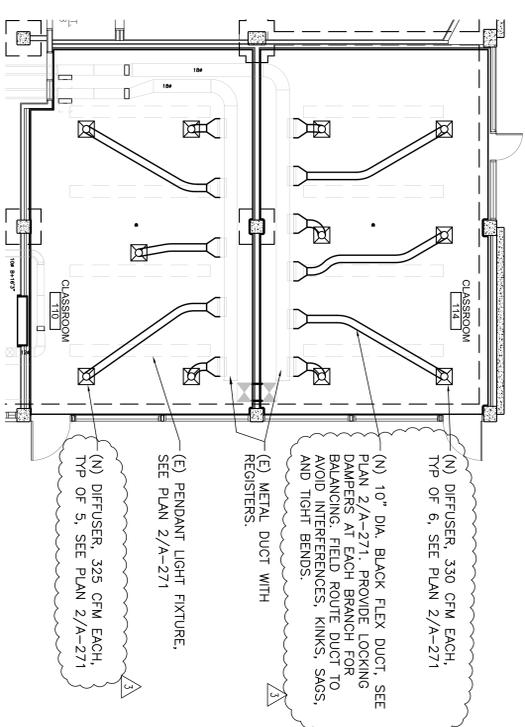


SUPPLY DUCT SCHEMATIC LAYOUT
SCALE 1/8"=1'-0"

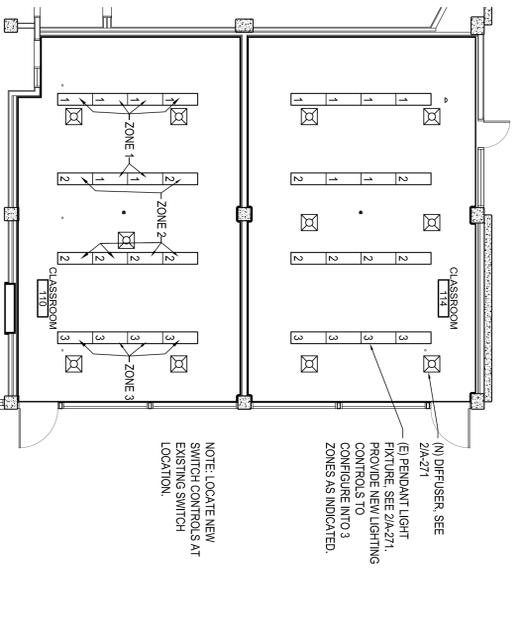

LIGHTING CONTROL SCHEMATIC LAYOUT
SCALE 1/8"=1'-0"

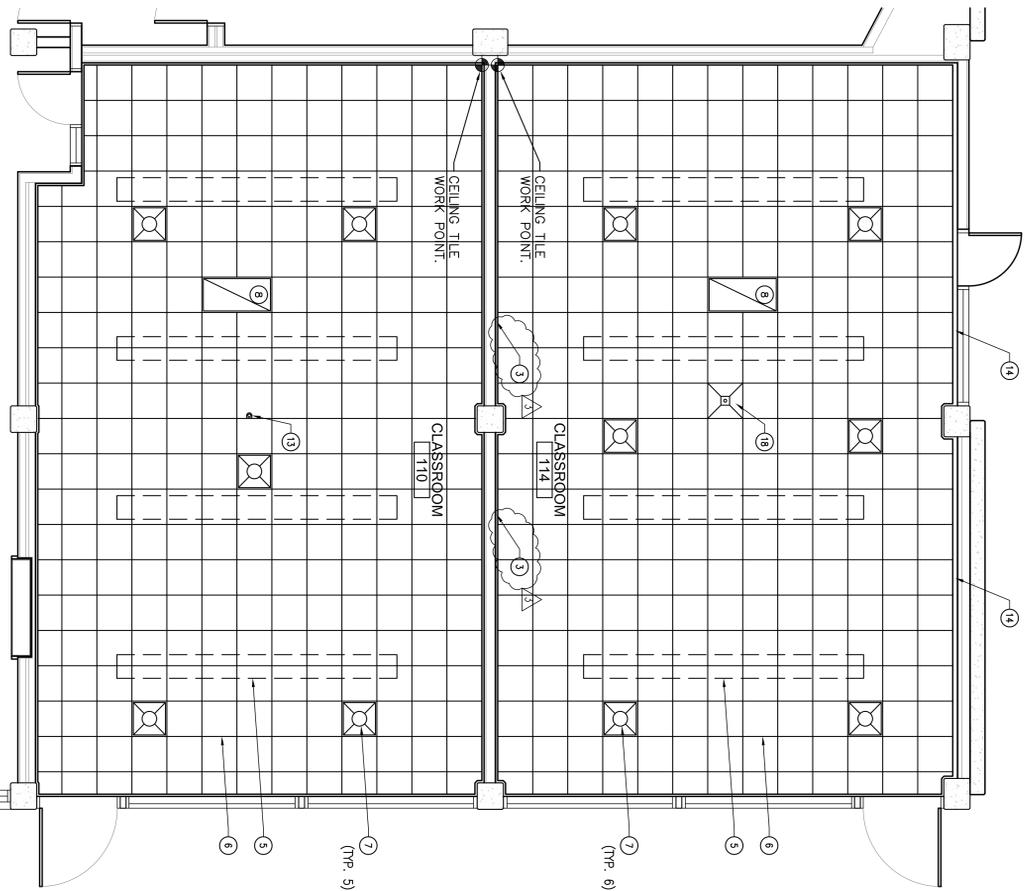

REFLECTED CEILING PLANS - NEW
SCALE 1/4"=1'-0"




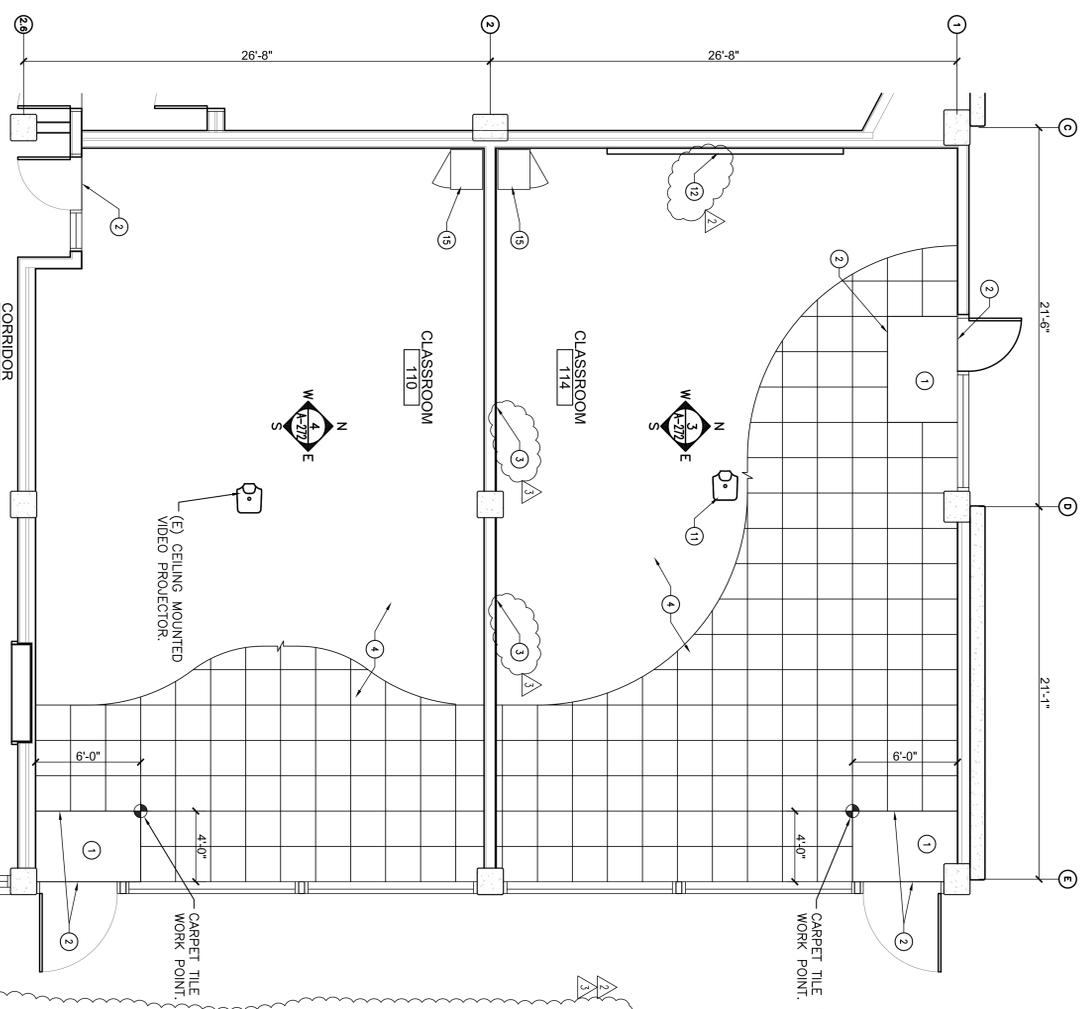


FLOOR PLANS - NEW
SCALE 1/4"=1'-0"

- | KEYNOTES |
|---|
| 1 (N) 48" x 72" WALK-OFF MAT - SEE FINISH SCHEDULE |
| 2 (N) FLOOR TRANSITION STRIP - SEE FINISH SCHEDULE AND SEE DETAILS |
| 3 REMOVE/INSTALL ONE LAYER OF 5/8" TYPE X CORPUS BOARD, REMOVE TO MATCH EXISTING WALLS, PAINT AND PAINT ON SOUTH WALL OF ROOM 114. |
| 4 (N) 2x7" CARPET TILE FLOOR FINISH - SEE FINISH SCHEDULE |
| 5 (E) CEILING PENDANT LIGHT FIXTURES TO REMAIN, PROVIDE BRACKING FOR (E) LIGHT SUPPORT CABLES, SEE NOTE 7 ON THIS SHEET. |
| 6 (N) ACOUSTICAL CEILING SYSTEM, 24"x24" - SEE FINISH SCHEDULE AND SEE DETAILS 1 TO 4 ON SHEET A-571. |
| 7 (N) CEILING SUPPLY DIFFUSER, NALOR "UN" 24"x24" TYPE L, FIELD VERIFY FINAL LOCATION TO AVOID CONFLICTS WITH OTHER SYSTEMS. |
| 8 (N) CEILING RETURN GRILLE, NALOR 4355 24"x48" TYPE L, FIELD VERIFY FINAL LOCATION TO AVOID CONFLICTS WITH OTHER SYSTEMS. |
| 9 NOT USED |
| 10 NOT USED |
| 11 (N) VIDEO PROJECTOR SYSTEM IN CLASSROOM 114 BY OTHERS, SEE FINISH SCHEDULE ON SHEET A-071 AND SEE DETAIL 9 ON SHEET A-571. |
| 12 (N) WALL MOUNTED PROJECTION SCREEN IN CLASSROOM 114 TO MATCH SCREEN IN CLASSROOM 110, SEE FINISH SCHEDULE AND SEE DETAIL 10/A-571. |
| 13 EXISTING PIPE SUPPORT USED FOR PENDANT MOUNTED PROJECTOR, PIPE SHALL NOT INTERFERE WITH EXPOSED TEE MAIN RUNNERS OR CROSS TEES. |
| 14 PROVIDE METAL FILLER PIECE OR EXTENDED FLANGE WALL MOLDING TO AVOID CEILING TILES LESS THAN 4" WIDE, USE TEE BAR GRID SYSTEM MANUFACTURER STANDARD UNIT AND ALIGN BOTTOM WITH WALL MOLDING, COLOR TO MATCH THE BAR FINISH. |
| 15 (N) LOCATION FOR IT/AV EQUIPMENT RACK (SIZE 22"x27"x24"), CONSULT WITH UNIVERSITY REPRESENTATIVE FOR SPECIFIC REQUIREMENTS. |
| 16 NOT USED |
| 17 NOT USED |
| 18 NEW METAL CEILING TILE PLATE FOR CEILING MOUNTED VIDEO PROJECTION SYSTEM BY A/C, FACTORY PAINT TO MATCH CEILING COLOR AND INSTALL PER MANUFACTURER SPECIFICATIONS, SEE DETAIL 9/A-571. |

- | NOTES |
|---|
| 1 EXTEND EXISTING FIRE SPRINKLER SYSTEM TO PROVIDE HEADS BELOW THE CEILING. AVOID SYSTEM FIRE DESIGN SHALL BE PROVIDED BY DESIGN/BUILD FIRE SPRINKLER SUBCONTRACTOR. SEE DETAIL 7/A-571. |
| 2 FOR KEYNOTE #3 THE FOLLOWING SHALL APPLY:
* REMOVE AND RESET EXISTING WOOD BASE OVER NEW LAYER OF Gypsum BOARD, PATCH, PRIME AND PAINT.
* EXTEND NEW LAYER OF Gypsum BOARD TO A HEIGHT OF 6 INCHES ABOVE THE NEW ACOUSTICAL CEILING TILE PERIMETER WALL MOLDING FOR FULL WIDTH OF EACH Gypsum BOARD FINISHED WALL PLANE.
* RESET EXISTING ELECTRICAL/DATA/TELECOM RECESSED WALL BOXES OR ADD EXTENSIONS TO EXISTING BOXES TO ALLOW RECEIPTABLE TO FLUSH WITH COVER PLATE. PROVIDE CONT. BEAD OF ACOUSTICAL SEALANT AT JOINT BETWEEN BOX AND NEW LAYER OF Gypsum BOARD. |
| 3 (E) ACOUSTICAL WALL PANELS IN CLASSROOMS SHALL BE REMOVED AND DISCARDED. AT THIS TIME THERE IS NO REQUIREMENT FOR THEM TO BE STORED ON SITE FOR USE ON FUTURE PROJECTS, SEE SHEET A-272. |
| 4 (E) EXTERIOR DOOR SILLS (3 TOTAL) - REMOVE, REPAIR AND RE-INSTALL WITH CONTINUOUS BEADS OF SEALANT TO FORM WATERIGHT CONDITION AT DOOR OPENING FROM SLAB, DOOR FRAME AND DOOR SILL. SEE DETAIL 6/A-571. |
| 5 REPOSITION EXISTING WALL MOUNTED ILLUMINATED "EXIT" SIGNS AT EACH DOOR TO CEILING MOUNTED SYSTEM IN NEW ACOUSTICAL LAY-IN CEILING. ALIGN WITH ORIGINAL LOCATION AND MOUNT USING SIGN MANUFACTURER'S SYSTEM FOR THIS CEILING CONDITION. |
| 6 EACH EXISTING WALL MOUNTED ADDRESS/VISUAL FIRE ALARM NOTIFICATION SHALL REMAIN IN EXISTING LOCATION, AND RE-INSTALL WITH NEW PANEL USING SIMILAR ATTACHMENT METHOD. SEE SHEET A-272. |
| 7 PENDANT HUNG LIGHT FIXTURES SHALL REMAIN. SUPPORTED DIRECTOR FROM CEILING AND PROVIDE THE CEILING SUSPENSION SYSTEM SHALL NOT PROVIDE ANY DIRECT SUPPORT. ASTM E880-5-17. COORDINATE CEILING LIGHT FIXTURE SUPPORT CABLES. LIGHT SUPPORT CABLE PENETRATIONS OF CEILING TILES SHALL HAVE ADAPTER (MATCH CEILING COLOR) TO ALLOW FREE MOVEMENT IN ALL HORIZONTAL DIRECTIONS. PROVIDE SHOP DRAWINGS OF SYSTEM FOR REVIEW AND APPROVAL BY UNIVERSITY PROJECT MANAGER. |
| 8 PAINT ALL WALLS TO MATCH EXISTING COLOR. |

<p>UNIVERSITY OF CALIFORNIA, MERCED FIRE MARSHAL</p> <p>Approval of this plan does not constitute or approve any construction or installation from stipulated drawings. The contractor shall be responsible for all field inspection. One set of approved plans shall be retained on the project site at all times. Revised by: _____ Date: _____ UCM Project No.: 000050</p>	<p>IDENTIFICATION STAMP DATE: _____ FILE NO. 0-100-MERCED APPL. NO. _____ AC: _____ FLS: _____ SS: _____</p>	<p>DATE: _____ NO. _____ ADDITIONAL #3 08.20.12</p>	<p>Drawn By: MH, BV, BW Revision Date: 06.28.2012 Plot Date: 06.28.2012 Scale: AS NOTED Key Plan</p>	<p>ADDENDUM 3</p>	<p>811 Know what's below. Call before you dig.</p>	<p>Drawing Title: NEW FLOOR PLANS & REFLECTED CEILING PLANS</p>	<p>Sheet Number: A-271</p>
	<p>Copyright Reserved The Contractor shall verify and be responsible for the accuracy of all information and be responsible for errors or omissions and be reported to Stantec drawings on the property of Stantec. This drawing is the property of Stantec. No part of this drawing may be reproduced, stored in a retrieval system, or transmitted in any form or by any means, electronic, mechanical, photocopying, recording, or by any information storage and retrieval system, without the prior written permission of Stantec, Inc. www.stantec.com</p>	<p>100% CONSTRUCTION DOCUMENTS Seals and Signatures</p>	<p>Stantec Consulting Services Inc. 1016 72nd Street N 1016 72nd Street (209) 521-8866 (209) 521-8945 fax www.stantec.com</p>	<p>Stantec Consulting Services Inc. 370 N Wight Lane, Suite 210 Merced, CA 95380 (925) 941-1400</p>	<p>Civil Engineer: Stantec</p>	<p>Project Name: University of California Merced, California Classroom and Office Building Rooms 110 & 114 Renovations</p>	<p>Project Number: 907015</p>

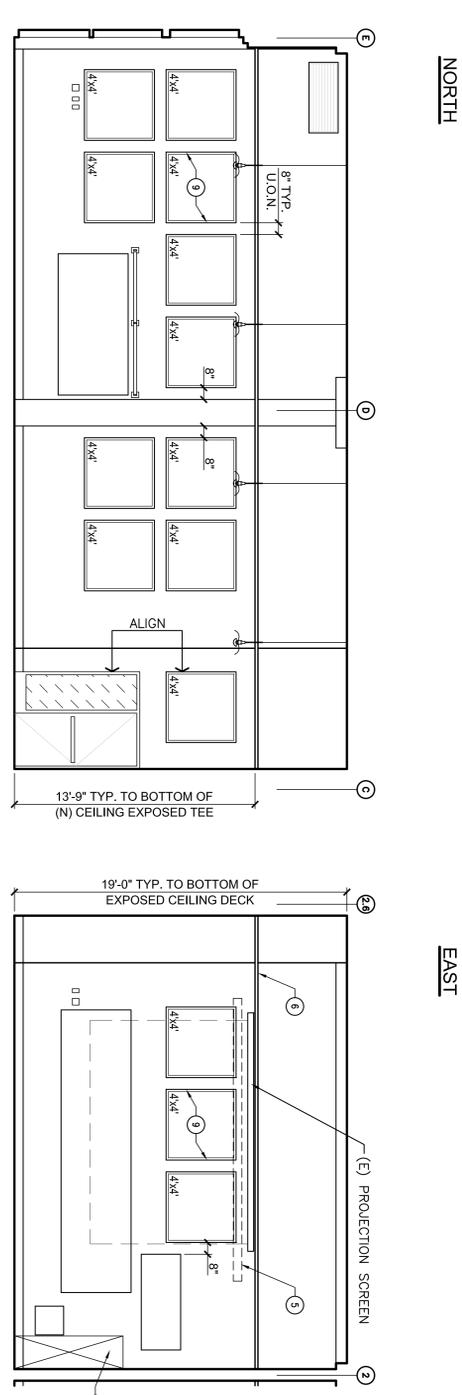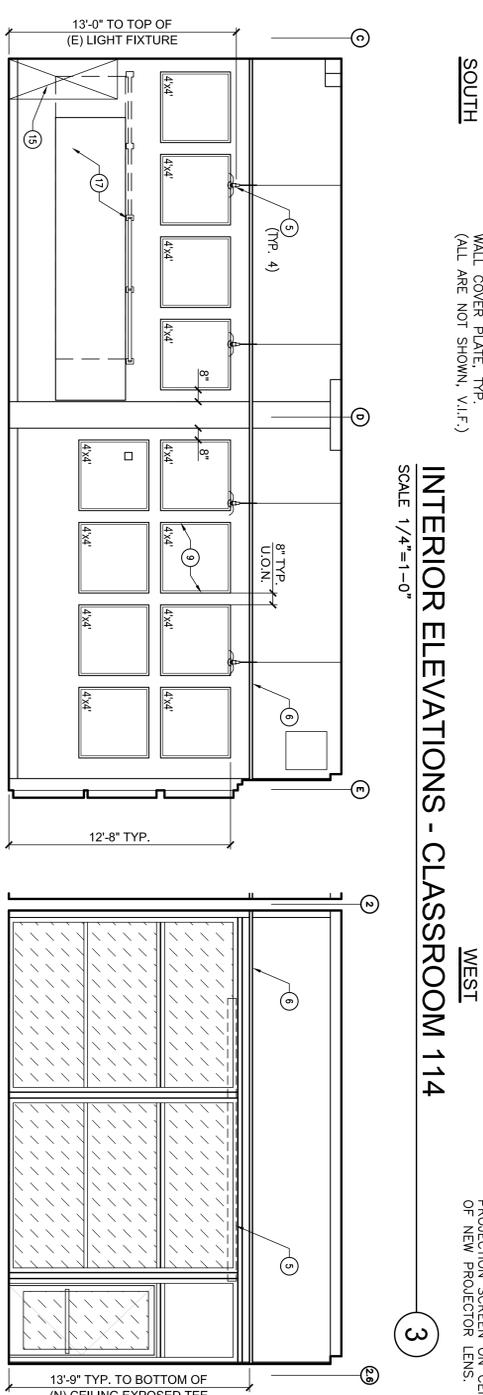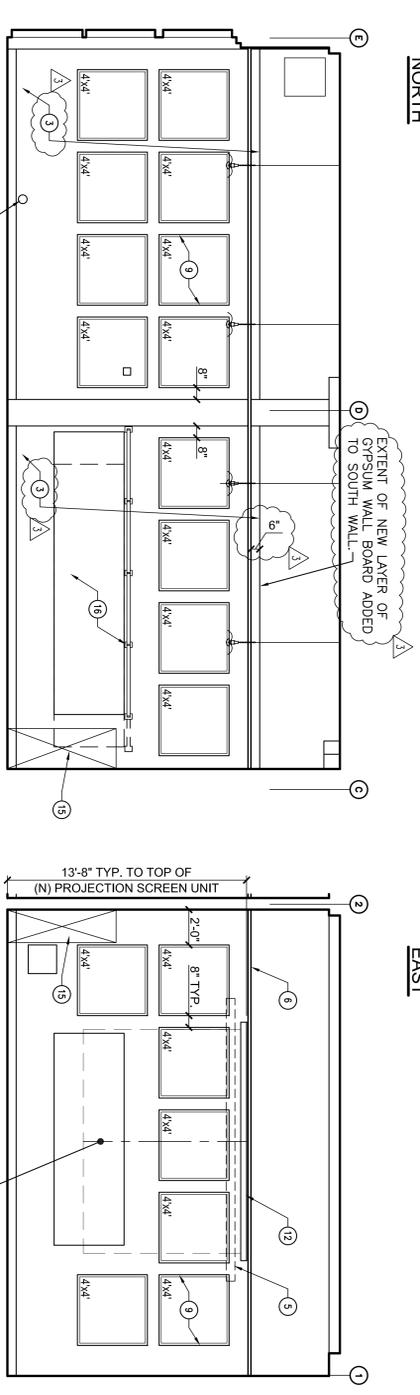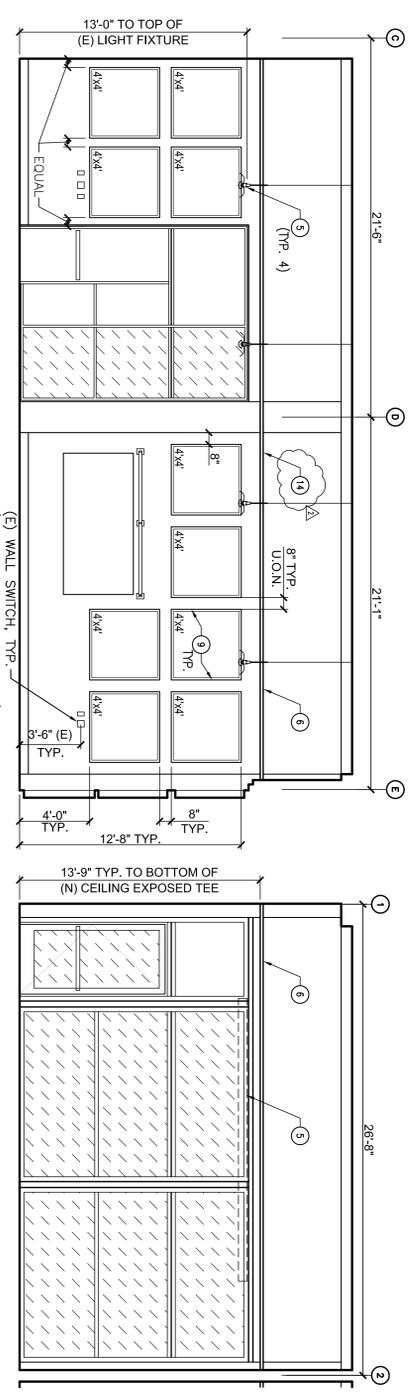

INTERIOR ELEVATIONS - CLASSROOM 114

INTERIOR ELEVATIONS - CLASSROOM 110

NOTES
1 EXTEND EXISTING FIRE SPRINKLER SYSTEM TO PROVIDE HEADS BELOW THE ACOUSTICAL CEILING SYSTEM. DESIGN SHALL BE PROVIDED BY DESIGN/BUILD FIRE SPRINKLER SUBCONTRACTOR. SEE DETAIL 1/A-571.
2 FOR KENOTE #3 THE FOLLOWING SHALL APPLY: REMOVE AND RESET EXISTING MOOD BESE OVER NEW LAYER OF GYPSUM BOARD. GYPSUM BOARD TO HANG 1/4" OF 6 INCHES ABOVE THE NEW ACOUSTICAL CEILING. THE GYPSUM BOARD FINISHED WALL PLANE. RESET EXISTING ELECTRICAL/DATA/TELECOM RECESSED WALL BOXES OR ADD EXTENSIONS TO EXISTING BOXES TO ALLOW RECEIPTABLE TO FLUSH WITH COVER PLATE. PROVIDE CONT. BEAD OF ACOUSTICAL SEALANT AT JOINT BETWEEN BOX AND NEW LAYER OF GYPSUM BOARD. * RESET EXISTING ELECTRICAL/DATA/TELECOM RECESSED WALL BOXES OR ADD EXTENSIONS TO EXISTING BOXES TO ALLOW RECEIPTABLE TO FLUSH WITH COVER PLATE. PROVIDE CONT. BEAD OF ACOUSTICAL SEALANT AT JOINT BETWEEN BOX AND NEW LAYER OF GYPSUM BOARD. (E) ACOUSTICAL WALL PANELS IN CLASSROOMS SHALL BE REMOVED AND DISCARDED. * TYPE REMOVE IS NO REQUIREMENT FOR THEM TO BE STORED ON SITE FOR USE ON FUTURE PROJECTS. SEE SHEET A-272.
3 (E) ACOUSTICAL WALL PANELS IN CLASSROOMS SHALL BE REMOVED AND DISCARDED. * TYPE REMOVE IS NO REQUIREMENT FOR THEM TO BE STORED ON SITE FOR USE ON FUTURE PROJECTS. SEE SHEET A-272.
4 (E) EXTERIOR DOOR SILLS (3 TOTAL) - REMOVE, REPAIR AND RE-INSTALL WITH CONTINUOUS BEADS OF SEALANT TO FORM WATERIGHT CONDITION AT DOOR OPENING FROM SLAB, DOOR FRAME AND DOOR SILL. SEE DETAIL 6/A-571.
5 REPOSITION EXISTING WALL MOUNTED ILLUMINATED "EXIT" SIGNS AT EACH DOOR TO CEILING MOUNTED SYSTEM IN NEW ACOUSTICAL UN- IN CEILING. ALIGN WITH ORIGINAL LOCATION AND MOUNT USING SIGN MANUFACTURER'S SYSTEM FOR THIS CEILING CONDITION.
6 EACH EXISTING WALL MOUNTED AUDIBLE/VISUAL FIRE ALARM NOTIFICATION SHALL REMAIN IN EXISTING LOCATION. REMOVE WITH REMOVAL OF EXISTING ACOUSTICAL PANEL ATTACHMENT METHOD. SEE SHEET A-272.
7 PENDANT HUNG LIGHT FIXTURES SHALL REMAIN. SPROCKET DIRECTLY FROM CEILING ABOVE. THE CEILING SUSPENSION SYSTEM SHALL NOT PROVIDE ANY DIRECT SUPPORT. ASTM E830-33.77 COORDINATE TO AILING MAN RAINERS AND CROSS THE LOCATION TO CABLE PENETRATIONS OF CEILING TILES SHALL HAVE ADAPTER MATCH CEILING COLOR) TO ALLOW FREE MOVEMENT IN ALL HORIZONTAL DIRECTIONS. PROVIDE SHOP DRAWINGS OF SYSTEM FOR REVIEW AND APPROVAL BY UNIVERSITY PROJECT MANAGER.
8 PAINT ALL WALLS TO MATCH EXISTING COLOR.

KEYNOTES
1 NOT USED
2 NOT USED
3 REMOVE/INSTALL ONE LAYER OF 5/8" TYPE X GYPSUM BOARD. TEXTURE TO MATCH EXISTING WALLS. PAINT AND PAINT ON SOUTH WALL OF ROOM 114.
4 NOT USED
5 (E) CEILING PENDANT LIGHT FIXTURES TO REMAIN. PROVIDE GROMMET AT EACH CEILING TILE PENETRATION AND SERVIC BRACKING FOR (E) UNID SUPPORT CABLES. SEE NOTE 7 ON THIS SHEET.
6 (N) ACOUSTICAL CEILING SYSTEM, 24"x24" - SEE FINISH SCHEDULE AND SEE DETAILS 1 TO 4 ON SHEET A-571.
7 NOT USED
8 NOT USED
9 (N) 1" THICK ACOUSTICAL WALL PANEL, MOUNT TO WALL WITH MANUFACTURER STANDARD Z-CORB SYSTEM. SIZES AS NOTED - SEE FINISH SCHEDULE AND SEE 6/A-571.
10 NOT USED
11 NOT USED
12 (N) WALL MOUNTED PROJECTION SCREEN IN CLASSROOM 114 TO MATCH SCREEN IN CLASSROOM 110. SEE FINISH SCHEDULE AND SEE DETAIL 10/A-571.
13 NOT USED
14 PROVIDE METAL FILLER PIECE OR EXTENDED FLANGE WALL MOLDING TO AVOID CEILING TILES LESS THAN 4" WIDE. USE THE BAR GRID SYSTEM MANUFACTURER STANDARD UNIT AND ALIGN BOTTOM WITH WALL MOLDING. COLOR TO MATCH THE BAR FINISH.
15 (N) LOCATION FOR IT/AV EQUIPMENT RACK (SIZE 22"Wx27"x74"H, CONSULT WITH UNIVERSITY REPRESENTATIVE FOR SPECIFIC REQUIREMENTS.
16 RELOCATE EXISTING MARKED BOARD AND LIGHT TO A POSITION ADJACENT TO CONCRETE PLASTER AT SAME ELEVATION. ADJUST WIRING AS REQUIRED. INSTALL USING SIMILAR METHOD OF ORIGINAL MOUNTING. PATCH AND REPAIR AS REQUIRED.
17 RELOCATE EXISTING MARKED BOARD TO A POSITION ADJACENT TO CONCRETE PLASTER AT SAME ELEVATION. MOVE LIGHT FIXTURE TO LOCATION USING EXISTING MOUNTING LOCATION. ADJUST WIRING AS REQUIRED. INSTALL USING SIMILAR METHOD OF ORIGINAL MOUNTING. PATCH AND REPAIR AS REQUIRED.
18 NEW METAL CEILING TILE PLATE FOR CEILING MOUNTED VIDEO PROJECTION SYSTEM BY A/C. FACTORY PAINT TO MATCH CEILING COLOR AND INSTALL PER MANUFACTURER SPECIFICATIONS. SEE DETAIL 9/A-571.

University of California
Merced, California

Project Name:
Site Development and Infrastructure Phase 4

Project Number:
906050

Civil Engineer:
Stantec

Stantec Consulting Services Inc.
1016 12th Street
Merced, CA 95324
(209) 321-8864 fax
(209) 321-9845 fax
www.stantec.com

Stantec Consulting Services Inc.
370 N West Lane, Suite 210
Merced, CA 95324
(209) 341-1400

Copyright Reserved

The Contractor shall be responsible for the accuracy of the information and for the accuracy of the drawings on the property of Stantec Consulting Services Inc. and the drawings shall be the work of Stantec Consulting Services Inc. and shall be the work of Stantec Consulting Services Inc.

100% CONSTRUCTION DOCUMENTS

Seals and Signatures:

UNIVERSITY OF CALIFORNIA, MERCED
FIRE MARSHAL

Any alteration or modification from stamped and signed drawings shall be the responsibility of the contractor. One set of approved plans shall be retained on the project site at all times.

DATE: _____
UNCM Project No.: 906050

IDENTIFICATION SHEET
DWG FILE NO. 0-DWG-MERGED
APPX. NO. _____
AC: FLS SS _____
DATE: _____





NO. ADDED/REMOVED: 2/0
NO. APPENDIX: 3/0
DATE: 08.20.12

Drawn By: MH, BV, BW
Revision Date: 04.19.2012
Plot Date: 04.19.2012
Scale: AS NOTED
Key Plan

ADDENDUM 3

Drawing Title:
NEW INTERIOR ELEVATIONS

Sheet Number:
A-272

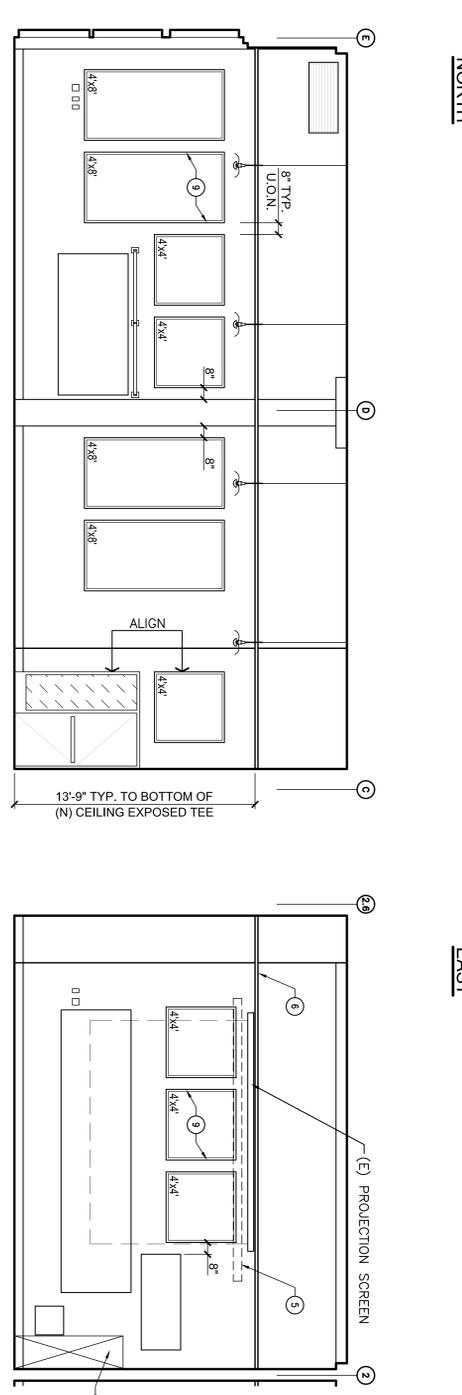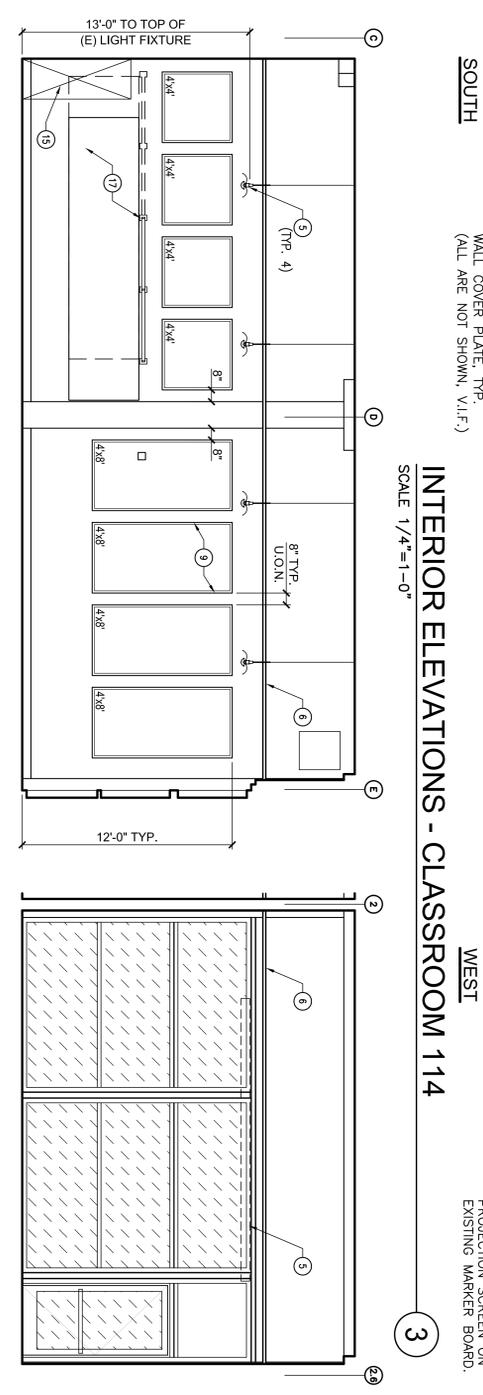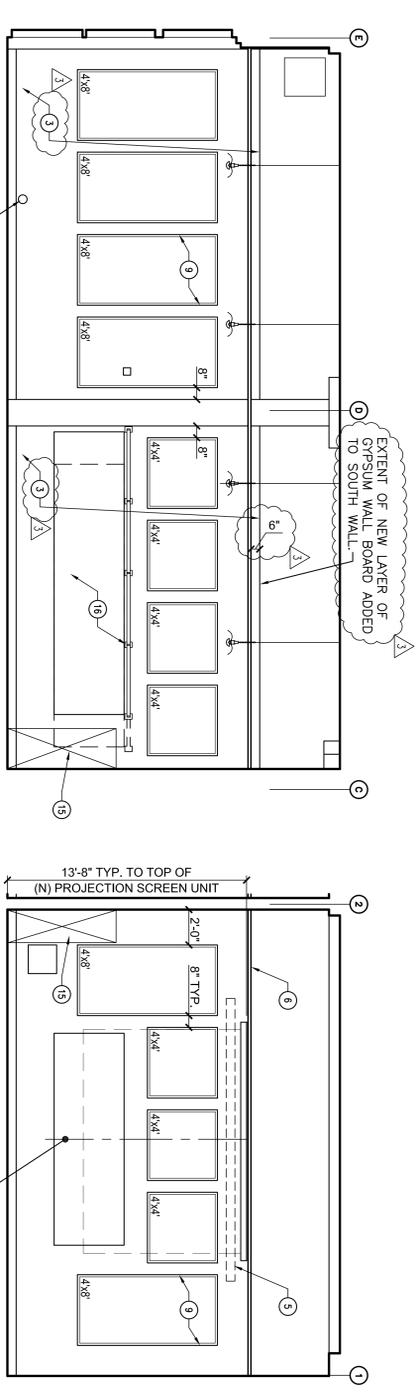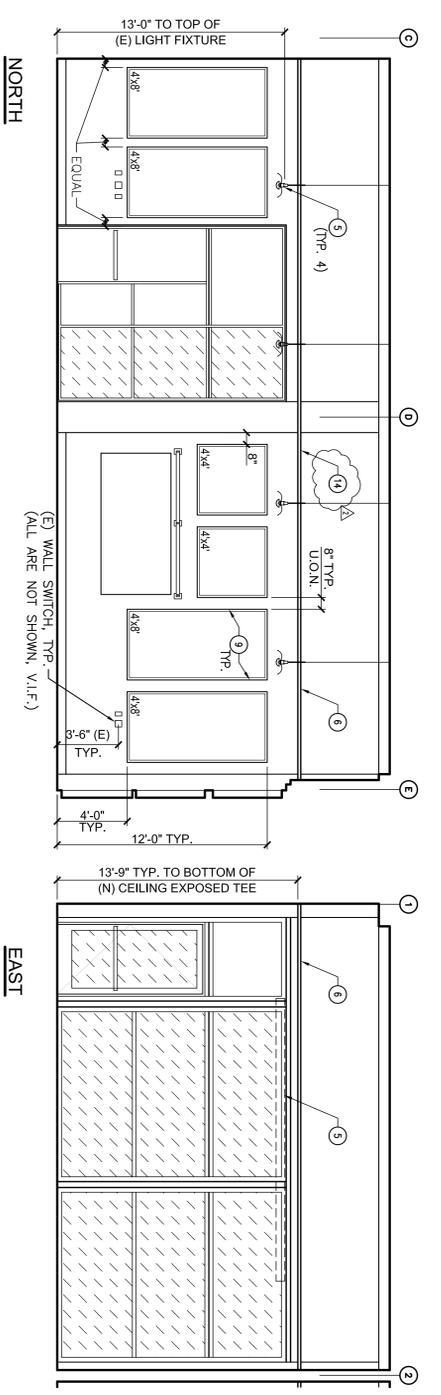

INTERIOR ELEVATIONS - CLASSROOM 114

INTERIOR ELEVATIONS - CLASSROOM 110

SCALE 1/4"=1'-0"

NOTES
1 EXTEND EXISTING FIRE SPRINKLER SYSTEM TO PROVIDE HEADS BELOW THE ACOUSTICAL CEILING SYSTEM. DESIGN SHALL BE PROVIDED BY DESIGN/BUILD FIRE SPRINKLER SUBCONTRACTOR. SEE DETAIL 1/A-571.
2 REMOVE AND RESET EXISTING MOOD BEE OVER NEW LAYER OF GYPSUM BOARD. GYPSUM BOARD TO HANG 1/2" OF 6 INCHES ABOVE THE NEW ACOUSTICAL CEILING. THE PRIMER WALL MOLDING FOR FULL WIDTH OF EACH GYPSUM BOARD FINISHED WALL PLATE.
3 (E) ACOUSTICAL WALL PANELS IN CLASSROOM SHALL BE REMOVED AND REINSTALLED IN THE SAME LOCATION AND FOR USE ON FUTURE PROJECTS. SEE SHEET A-272.
4 (E) EXTERIOR DOOR SILLS (3 TOTAL) - REMOVE, REPAIR AND RE-INSTALL WITH CONTINUOUS BEADS OF SEALANT TO FORM WATERIGHT CONDITION AT DOOR OPENING FROM SLAB, DOOR FRAME AND DOOR SILL. SEE DETAIL 6/A-571.
5 REPOSITION EXISTING WALL MOUNTED ILLUMINATED "EXIT" SIGNS AT EACH DOOR TO CEILING MOUNTED SYSTEM IN NEW ACOUSTICAL UNIT-IN CEILING. ALIGN WITH ORIGINAL LOCATION AND MOUNT USING SIGN MANUFACTURER'S SYSTEM FOR THIS CEILING CONDITION.
6 EACH EXISTING WALL MOUNTED AUDIBLE/VISUAL FIRE ALARM NOTIFICATION SHALL REMAIN IN EXISTING LOCATION. REMOVE WITH REMOVAL OF EXISTING ACOUSTICAL PANEL ATTACHMENT METHOD. SEE SHEET A-272.
7 PENDANT HUNG LIGHT FIXTURES SHALL REMAIN. SUPPORTED DIRECTLY FROM CEILING ABOVE. THE CEILING SUSPENSION SYSTEM SHALL NOT PROVIDE ANY DIRECT SUPPORT. ASTM E880-53.77 COORDINATE TO ARCHITECT FOR HANGERS AND CROSS TIE LOCATION TO ALLOW PENETRATIONS OF CEILING TILES SHALL HAVE ADAPTER MATCH CEILING COLOR TO ALLOW FREE MOVEMENT IN ALL HORIZONTAL DIRECTIONS. PROVIDE SHOP DRAWINGS OF SYSTEM FOR REVIEW AND APPROVAL BY UNIVERSITY PROJECT MANAGER.
8 PAINT ALL WALLS TO MATCH EXISTING COLOR.

BID ALTERNATE NOTE:
PROVIDE ACOUSTICAL WALL PANEL WORK ON THIS SHEET A-272a INSTEAD OF ACOUSTICAL WALL PANEL WORK SHOWN ON SHEET A-272. ALL OTHER WORK ARE THE SAME ON TWO SHEETS.

KEYNOTES
1 NOT USED
2 NOT USED
3 REMOVE/INSTALL ONE LAYER OF 5/8" TYPE X GYPSUM BOARD. TEXTURE TO MATCH EXISTING WALLS. PAINT AND PAINT ON SOUTH WALL OF ROOM 114.
4 NOT USED
5 (E) CEILING PENDANT LIGHT FIXTURES TO REMAIN. PROVIDE GROMMET AT EACH CEILING TILE PENETRATION AND SEMI-BRACING FOR (E) LIGHT SUPPORT CABLES. SEE NOTE 7 ON THIS SHEET.
6 (N) ACOUSTICAL CEILING SYSTEM, 24"x24" - SEE FINISH SCHEDULE AND SEE DETAILS 1 TO 4 ON SHEET A-571.
7 NOT USED
8 NOT USED
9 (N) 1" THICK ACOUSTICAL WALL PANEL, MOUNT TO WALL WITH MANUFACTURER STANDARD 2-COIL SYSTEM. SIZES AS NOTED - SEE FINISH SCHEDULE AND SEE 8/A-571.
10 NOT USED
11 NOT USED
12 (N) WALL MOUNTED PROJECTION SCREEN IN CLASSROOM 114 TO MATCH SCREEN IN CLASSROOM 110. SEE FINISH SCHEDULE AND SEE DETAIL 10/A-571.
13 NOT USED
14 PROVIDE METAL FILLER PIECE OR EXTENDED FLANGE WALL MOLDING TO AVOID CEILING TILES LESS THAN 4" WIDE. USE THE BAR GRID SYSTEM MANUFACTURER STANDARD UNIT AND ALIGN BOTTOM WITH WALL MOLDING. COLOR TO MATCH THE BAR FINISH.
15 (N) LOCATION FOR IT/AV EQUIPMENT RACK (SIZE 22"x27"x74") CONSULT WITH UNIVERSITY REPRESENTATIVE FOR SPECIFIC REQUIREMENTS.
16 RELOCATE EXISTING MARKED BOARD AND LIGHT TO A POSITION ADJACENT TO CONCRETE PLASTER AT SAME ELEVATION. ADJUST WIRING AS REQUIRED. INSTALL USING SIMILAR METHOD OF ORIGINAL MOUNTING. PATCH AND REPAIR AS REQUIRED.
17 RELOCATE EXISTING MARKED BOARD TO A POSITION ADJACENT TO CONCRETE PLASTER AT SAME ELEVATION. MOVE LIGHT FIXTURE TO LOCATION USING EXISTING MOUNTING LOCATION. ADJUST WIRING AS REQUIRED. INSTALL USING SIMILAR METHOD OF ORIGINAL MOUNTING. PATCH AND REPAIR AS REQUIRED.
18 NEW METAL CEILING TILE PLATE FOR CEILING MOUNTED VIDEO PROJECTION SYSTEM BY A/C. FACTORY PAINT TO MATCH CEILING COLOR AND INSTALL PER MANUFACTURER SPECIFICATIONS. SEE DETAIL 9/A-571.

University of California
Merced, California

Project Name:
Classroom and Office Building Rooms 110 & 114 Renovations

Project Number:
907015

Civil Engineer:
Stantec

Stantec Consulting Services Inc.
1016 12th Street
Merced, CA 95324
(209) 321-8864 fax
www.stantec.com

Stantec Consulting Services Inc.
370 N West Lane, Suite 210
Merced, CA 95328
(209) 341-1400

Mechanical Engineer/Electrical Engineer

Copyright Reserved

The Contractor, its agents, and its representatives for services of construction shall be required to Stantec Consulting Services Inc. for the purpose of protecting the property of Stantec Consulting Services Inc. and its representatives. This drawing is the property of Stantec Consulting Services Inc. and is not to be reproduced, stored in a retrieval system, or transmitted in any form or by any means, electronic, mechanical, photocopying, recording, or by any information storage and retrieval system, without the prior written permission of Stantec Consulting Services Inc.

100% CONSTRUCTION DOCUMENTS

Seals and Signatures:

UNIVERSITY OF CALIFORNIA, MERCED
FRED MARSHALL
Any alteration or modification from published information on this drawing does not constitute an approval or endorsement by the University of California, Merced. One set of approved plans shall be maintained on the project site at all times.
Revised by: _____
Date: _____
UCM Project No.: 906050

IDENTIFICATION SHEET
DWG FILE NO. 0-DIG-MERGED
APPX. NO. _____
AC: FLS SS _____
DATE: _____

NO. ADDED/REMOVED: 2/0
NO. APPROPRIATE: 3/3
NO. OBSOLETE: 0/0
DATE: 08.20.12

Drawn By: MH, BV, BW
Revision Date: 08.28.2012
Plot Date: 06.28.2012
Scale: AS NOTED
Key Plan

ADDENDUM 3

Drawing Title:
NEW INTERIOR ELEVATIONS (BID ALTERNATE)

Street Number:
A-272(a)

