WELLNESS CENTER REMODEL UNIVERSITY OF CALIFORNIA, MERCED MERCED, CALIFORNIA

Project Name:

UNIVERSITY OF CALIFORNIA, MERCED

WELLNESS CENTER REMODEL

Project Number:

907432

BID ADDENDUM No. 01 (Identified as *Revision 2*)

To the

CONTRACT DOCUMENTS

August 6, 2012

I. Bidder acknowledges that it is the Bidder's responsibility to ascertain whether any Addenda have been issued and if so, to obtain copies of such Addenda. Bidder therefore agrees to be bound by all Addenda that have been issued for this bid.

This Addendum forms a part of the Contract Documents and modifies the original Bidding Documents. The following changes, additions, or deletions have been made to the following documents as indicated and all other Contract Documents shall remain the same.

II. CLARIFICATIONS

A. PRE-BID-

- 1. On Sheet A10.1; REVISE "VT-3" color to MVT 6044.
- 2. On Detail 6/S1.2; Simpson PDPW-300 anchors to be spaced @ 32" oc.
- 3. On Detail 21/S1.2; REVISE angle to 1 ¾ x1 ¾ x 5/16", spaced @ 32" oc., max.

III. CHANGES TO BIDDING DOCUMENTS

- A. BIDDING / CONTRACT DOCUMENTS AND DIVISION 1 SPECIFICATIONS (VOLUME 1 OF 3)
 - Project Directory: REVISE Architect's address to; 1207 13th Street, Suite #6 Modesto, CA 95354
- B. MATERIAL SPECIFICATIONS- DIVISIONS 2-17 (VOLUME 2 OF 3)
 - 1. Specification Section 06411 Casework: DELETE entire section and replace with new specification section attached to this Addendum.
- C. DRAWINGS (VOLUME 3 OF 3)
 - 1. Architectural drawing A2.2.2: REVISE sheet as indicated on new drawings SK.1 & SK.2 attached to this Addendum.

- PROJECT NO.: 907432
- 2. Architectural drawing A5.1: DELETE entire sheet and replace with new sheet attached to this Addendum.
- 3. Electrical drawings E0.0, E5.1 and E5.2: DELETE entire sheets and replace with new sheets attached to this Addendum.

UNIVERSITY OF CALIFORNIA, MERCED

By: University of California, Merced

University's Representative

Allison Costa

Project Manager


Enclosure:

Specifications; Section 06411- Casework.

Drawings; SK.1, SK.2, A5.1, E0.0, E-5.1, E3-5.2.

Support documents; OPA-0697-07, OPA-1665-07.

End of Bid Addendum No. 01

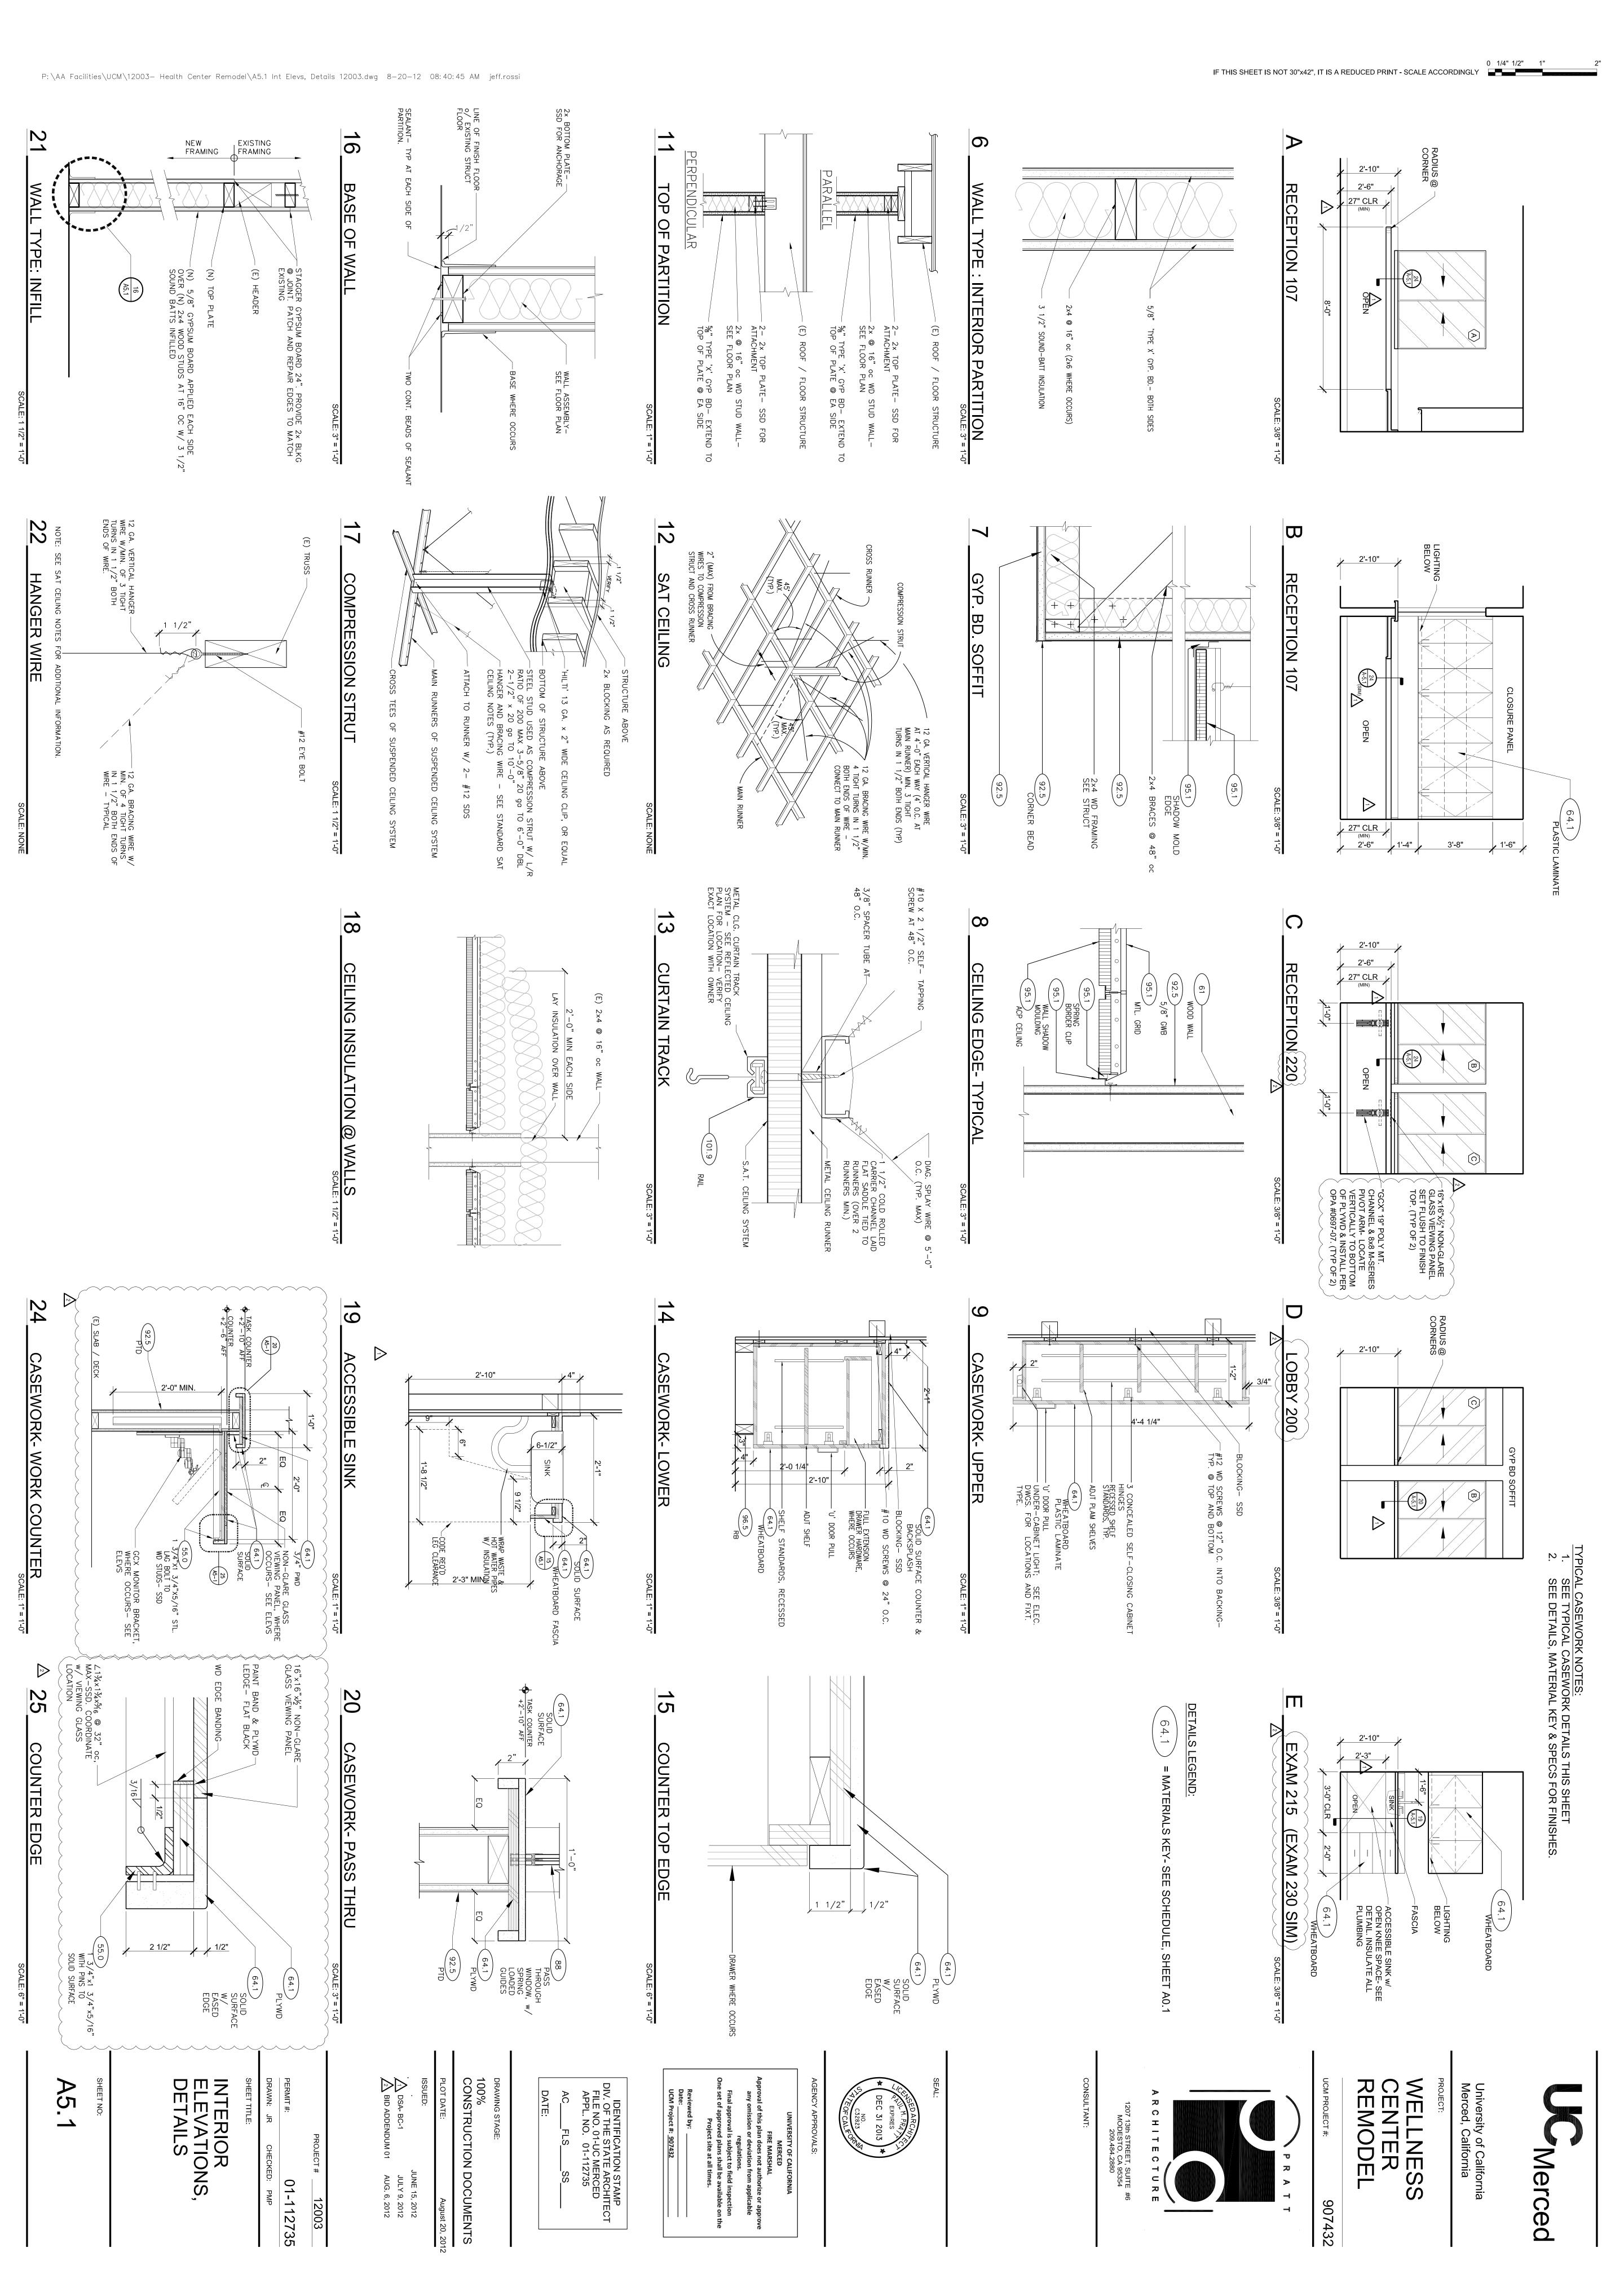

SECTION 06411 - CASEWORK

PART 1 - GENERAL

1.1 SUMMARY

- A. Work Included: Casework, complete, as shown and specified.
- B. Work Specified Elsewhere:
 - 1. LEED™ Requirements: Section 01 81 13.
 - 2. Backing Plates: Section 09250.
 - 3. Trim, Panel work and Other Architectural Woodwork: Section 06400.
- 2
- 4. Adhesives, Sealers and Paints: Section 09051.
- 5. Resilient Flooring: Section 09650.
- 6. Plumbing Fixtures, Fittings, and Connections: (See Plans).
- 7. Electrical Connections, Wiring, Disconnect Switches, and Similar Items: (See Plans).

1.2 REFERENCE STANDARDS

- A. Woodwork Institute (WI):
 - 1. Manual of Millwork.

1.3 SUBMITTALS

- A. Product Data: Manufacturer's specifications, data, and installation instructions.
- B. Shop Drawings: Show materials, components, profiles, elevations, assembly methods, joint details, fastening methods, accessory listings, hardware locations, utilities to be incorporated into casework such as power, signal, and communications systems, and schedule of finishes.

C. Samples:

- 1. Cabinet Hardware: Full-size complete example of each specified unit.
- 2. Wheatboard: 12-inch-square.
- 3. Solid Surfacing Material: 12-inch-square sample.
- 4. Plastic Laminate: 2"x3".

WELLNESS CENTER REMODEL UNIVERSITY OF CALIFORNIA, MERCED MERCED, CALIFORNIA

D. Certificates: Prior to delivery to Project site, submit WI Certified Compliance Certificate certifying Shop Drawings and products furnished for Project meet requirements of specified grades.

1.5 QUALITY ASSURANCE

A. Qualifications:

- 1. Fabricator: Secure Reinspection Service of Woodwork Institute (WI).
- B. Compliance Label: Each unit of architectural woodwork shall bear WI Certified Compliance Label indicating compliance with grade specified.

1.6 PRODUCT HANDLING

- A. General: Per Reference Standard and as specified.
- B. Delivery: Do not deliver casework until painting, finishing, and overhead work is complete in applicable spaces.
- C. Storage: Store casework with in project area, out of the way of other construction activities, at a relative humidity of 50 percent to 55 percent at 70 degrees F.
- D. Handling: Handle casework with care so as not to damage surfaces and edges or subject cases to stress.

1.7 PROJECT CONDITIONS

A. Coordination:

- 1. Prior to submission of shop drawings, coordinate requirements of equipment to be installed in casework such as signal system, communication system, sinks, and electrical outlets.
- 2. Conflicts: Identify any conflict between equipment and window and door trim and casework requirements on shop drawings.
- 3. Fabrication: Do not proceed until conflicts have been resolved.

PART 2 - PRODUCTS

2.1 MATERIALS

- A. Wheatboard: Kirei, or equal to match existing material, 3/4-inch thick with transparent finish to match existing material.
- B. Edge Banding: 1/4" thick solid maple edge banding. Secure with wood adhesive.

C. Solid Surfacing Material:

1. Manufacturers:

a. First Floor;

Wilsonart International, Solid Surfaces, or equal, homogenous sheet with methyl methacrylate binder. ½" thick unless otherwise shown. Bond parts with adhesive recommended by sheet manufacturer.

- 1) Color: Baja Melange #9030
- b. Second Floor;

DuPont's Corian, to match existing material, homogenous sheet with methyl methacrylate binder. ½" thick unless otherwise shown. Bond parts with adhesive recommended by sheet manufacturer.

1) Color: Adobe

D. Wood:

1. General: Except for hardwood and hardwood veneer, fire retardant treat wood, plywood, and particleboard used for Work of this Section.

2. Lumber:

- a. Softwood: Douglas fir, custom grade.
- b. Hardwood:
 - 1) Grade: Premium.
 - 2) Species: Maple.
 - 3) Finish: Transparent.
- c. Medium Density Fiberboard (MDF): Medite II, as manufactured by Medite Corporation or equal.
 - 1) Fabricate without added urea-formaldehyde resins.
- d. Particleboard:
 - 1) General: Provide Resincore I, as manufactured by Rodman Industries or equal, complying with the following:
 - 2) Fabricate from particleboard with phenol-based adhesives.

3) Plywood:

- a. Doug Fir Plywood: ¾-inch thick (19mm) 15 ply veneer plywood with premium grade vertical grain Douglas fir face and back plies.
- E. Plastic Laminate (vertical surfaces):
 - 1. Manufacturer: Wilsonart International, or equal.
 - 2. Color: Fusion Maple #7909-60.
- F. Cabinet Hardware: Per Reference Standards and as follows:
 - 1. Finish: US26D, unless otherwise specified.
 - 2. Hinges:
 - a. Concealed: European style, all-metal construction, 170-degree minimum opening, self-closing.
 - b. Continuous: Stanley, or equal, 314-1/4, heavy-gauge brass, 1-1/2 inches wide unless otherwise shown.
 - c. Invisible: Universal Industrial Product Co.'s Soss 216, 218, and 220 Series, or equal, fully concealed hinge where no part is visible from either side in closed position. Operable to full 180- degree open. Cast brass or bronze.
 - d. Pivot: Stanley 327, or equal, top and bottom pivot set, polish pivot edges before finishing, one set per each door thicker than 1 inch.
 - 3. Door and Drawer Pulls:
 - a. Type 1: EPCO No. MC-402-4 DC, or equal.
 - 4. Locks:
 - a. General: 6-pin tumbler, dead bolt type.
 - b. Drawers: Schlage CL 2009-Series or equal, one per drawer.
 - c. Doors: Schlage CL1000-Series or equal, one per active door leaf.
 - d. Keying: Key locks in same room alike, key locks in different rooms different, unless otherwise directed. Furnish two change keys per lock and six master keys per system.

5. Drawer Slides:

- a. Box Drawer: Accuride 3832 or equal, 100-pound capacity, full extension.
- b. Flat File Drawer: Accuride 4034, or equal, 150-pound capacity, full extension.
- 6. Supports for Adjustable Shelves in Casework:
 - a. Manufacturer: Haefele or equal.
 - b. Description: Provide 4 rows of 5mm diameter holes, at 1-inch centers, full-height in every case shown to have adjustable shelves. Support each shelf on four Haefele No. 282.24.722 nickel-plated zinc alloy plug-in supports with shelf-fixing lugs.
 - c. Contractor's Option: In lieu of above, provide four full-height Haefele No. 283.05.017 nickel-plated steel shelf strips per case and four Haefele No. 283.51.706 nickel-plated steel shelf supports per shelf. Surface mount shelf strips and notch shelves at each strip to provide lateral restraint.
- 7. Miscellaneous Items: Provide following per WI Supplement No. 1 to Sections 14 and 15.
 - a. Magnetic catches.
 - b. Elbow catches.
 - File followers.
 - d. Glides.

F. Fasteners:

- 1. General: As required by Reference Standard and recommended by manufacturer for intended use.
- 2. Wood Screws: Cadmium-plated steel, sizes as shown.
- 3. Sheet Metal Screws: Cadmium-plated steel, sizes as shown.
- 4. Sheet Metal Angles: Fabricate angles from galvanized steel sheet, sizes and gauges as shown.
- G. Counter Supports: Custom fabricate from stainless steel as shown with joints welded and ground smooth and all sharp edges and corners eased and smooth.

2.2 FABRICATION

A. General:

- 1. Field Measurements: Verify dimensions and plumbness and trueness of wall or partition as required for proper fabrication of the Work.
- 2. Cut-outs: Insofar as possible, make cut-outs required to accommodate work of other Sections in shop.
- 3. Shop Fabrication: Shop-fabricate casework in whole units or in partial units as most practical for handling and transportation. Assemble partial units in place in such manner that each piece of casework becomes a unified whole visually and structurally. Fabricate fillers and scribe strips of same materials and finishes as cabinets with which they are associated.
- 4. Hardware: Make cuts for hardware neat and true. Install hardware and fit securely.
- 5. Adjustment: Adjust drawers, doors, and movable shelves to operate easily and smoothly without either binding or excessive play.
- 6. Back Painting: Surfaces of casework which are not exposed to view at any time and abut walls or floor shall be thoroughly back painted with one heavy coat of finishing material of fabricator's choice before leaving fabricator's shop.
- 7. End Panels, Filler Panels, and Closure Panels: Fabricate as shown from material specified for casework doors. Secure to casework and adjacent construction with concealed fasteners as shown.

B. Wheatboard Casework:

- 1. Applicable Standard: WI Section 14 Wood Casework.
- 2. Grade: Premium.
- 3. Construction Style: Style A Frameless.
- 4. Construction Type: Type I.
- 5. Door and Drawer Front Style: Flush Overlay.
- 6. Cabinet Door and Banding Type: I.
- 7. Scribing: Flush with door faces and per Premium Grade regardless of specified casework grade.
- 8. Materials:
 - a. Exposed Surfaces: Wheatboard; with transparent finish

- b. Semi-Exposed Surfaces: Wheatboard; with transparetnt finish.
- c. Edges: Specified edge banding.
- C. Plastic Laminated Casework.
 - 1. General: Same as wheatboard casework except as follows:
 - 2. Materials:
 - a. Exposed Surfaces: Plastic Laminate.
 - b. Semi-Exposed Surfaces: Melamine, white.
 - c. Edges: Plastic Laminate to match face veneer.

D. Special Countertops:

1. Solid Surfacing Material: Per Reference Standard, Premium Grade, and manufacturer's written instructions.

2.3 FINISHING

- A. General: Factory finish casework prior to delivery and installation per WI Section 25 Factory Finishing of Architectural Millwork.
- B. Opaque Finish: WI System No. 7 Synthetic Enamel, special colors and sheen, as selected.
- C. Transparent Finish: WI System No. 3 Conversion Varnish, special stain or dye and sheen to match existing material.

PART 3 - EXECUTION

3.1 EXAMINATION

A. Verification of Conditions: Verify trueness of wall and floor substrates and adequacy of backing and support framing. Do not commence installation until conditions are satisfactory.

3.2 PREPARATION

A. General: Remove casework from its crates or protective wrappings as near site of installation as possible.


3.3 **INSTALLATION**

- A. General: Comply with WI Section 26 Installation of Architectural Millwork. Install casework plumb and level; shim as necessary with concealed shims; accurately scribe and closely fit faceplates, filler strips, and trim strips to irregularities of adjacent surfaces.
- B. Maximum Allowable Gap: 1/16-inch.
- C. Casework Tops: Install so that they will lie in one plane, without gaps between tops and casework.
- D. Closure: Install as shown with tight hairline butt joints between panels.
- E. Backing Plates and Blocking: Secure casework to structural backing with fasteners as shown.
- Wall-Mounted Adjustable Shelves: Secure shelf support system standards to backing plates. Secure F. shelves to shelf rests of knife brackets of shelf support system with wood screws.
- G. Holes and Cut-Outs: Except those made in shop, make required holes and cutouts in casework as required for pipes, conduits, and other penetrations, or inserts provided as part of work of other Sections. Make provisions for access to plumbing valves and cleanouts, and connection of electrical work.
- H. Hardware Installation: Install auxiliary items after final finishing has been completed. Install hinges to fit snugly, flat in mortises or on surfaces. Turn screws to a flat seat.
- Grommets: Install in locations as directed in field by University's Representative.
- Anchoring and Fastening Devices: Provide as required by Work of this Section for installation, including wood and sheet metal screws, bolts, toggle bolts, lag screws and expansion shields, among others.

3.4 ADJUSTING AND CLEANING

- A. Defective Work: Touch-up, refinish, or replace damaged, stained, scratched, or otherwise disfigured portions of the Work to satisfaction of Architect.
- B. Cleaning: After installation, wipe finished surfaces to remove marks of handling, clean and polish hardware in accordance with manufacturer's recommendations, and leave in clean condition.
- C. Protection: Protect casework against damage until Work is accepted.

END OF SECTION 06411

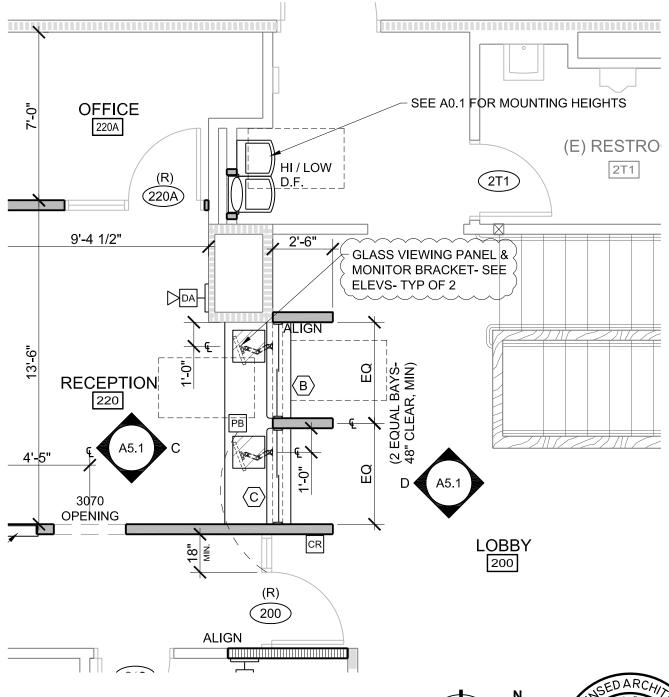

PARTIAL FLOOR PLAN



SCALE: 1/4"=1'-0"





Merced
Wellness Center

REMODEL

UCM PROJECT #: 907432

REFERENCE DRAWING:

A2.2.2

12003


TITLE:

BID ADDENDUM 01 RECEPTION 220-FLOOR PLAN DATE: August 06, 2012

PROJECT #:


SHEET NO:

SK.1

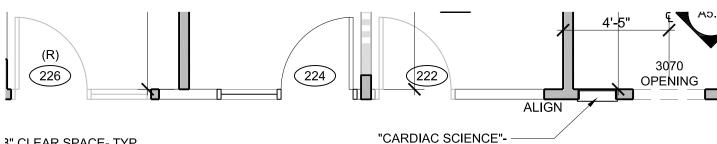

3" CLEAR SPACE- TYP.

SEMI-RECESSED AED CABINET. MOUNT AT 40" AFF TO CENTER OF HANDLE.

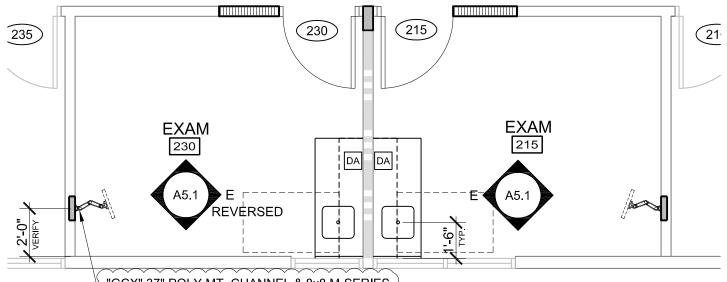

"GCX" 37" POLY MT. CHANNEL & 8x8 M-SERIES PIVOT ARM- INSTALL PER OPA -1665-07. PATCH & REPAIR WALL. PROVIDE KEYBD, PRINTER & CPU TRAY OPTIONS- INSTALL w/ SAME **DIMENSIONAL PROPERTIES &** CONFIGURATION AS EXISTING ASSEMBLIES. (TYP OF 2)

PARTIAL FLOOR PLAN



SCALE: 1/4"=1'-0"





Merced

WELLNESS CENTER **REMODEL**

UCM PROJECT #:

907432

REFERENCE DRAWING:

A2.2.2

TITLE:


BID ADDENDUM 01 EXAMS 215 & 230 FLOOR PLAN


12003 PROJECT #: August 06, 2012 DATE: SHEET NO:

SK.2

Approval of this plan does not authorize or approve

E-0.0

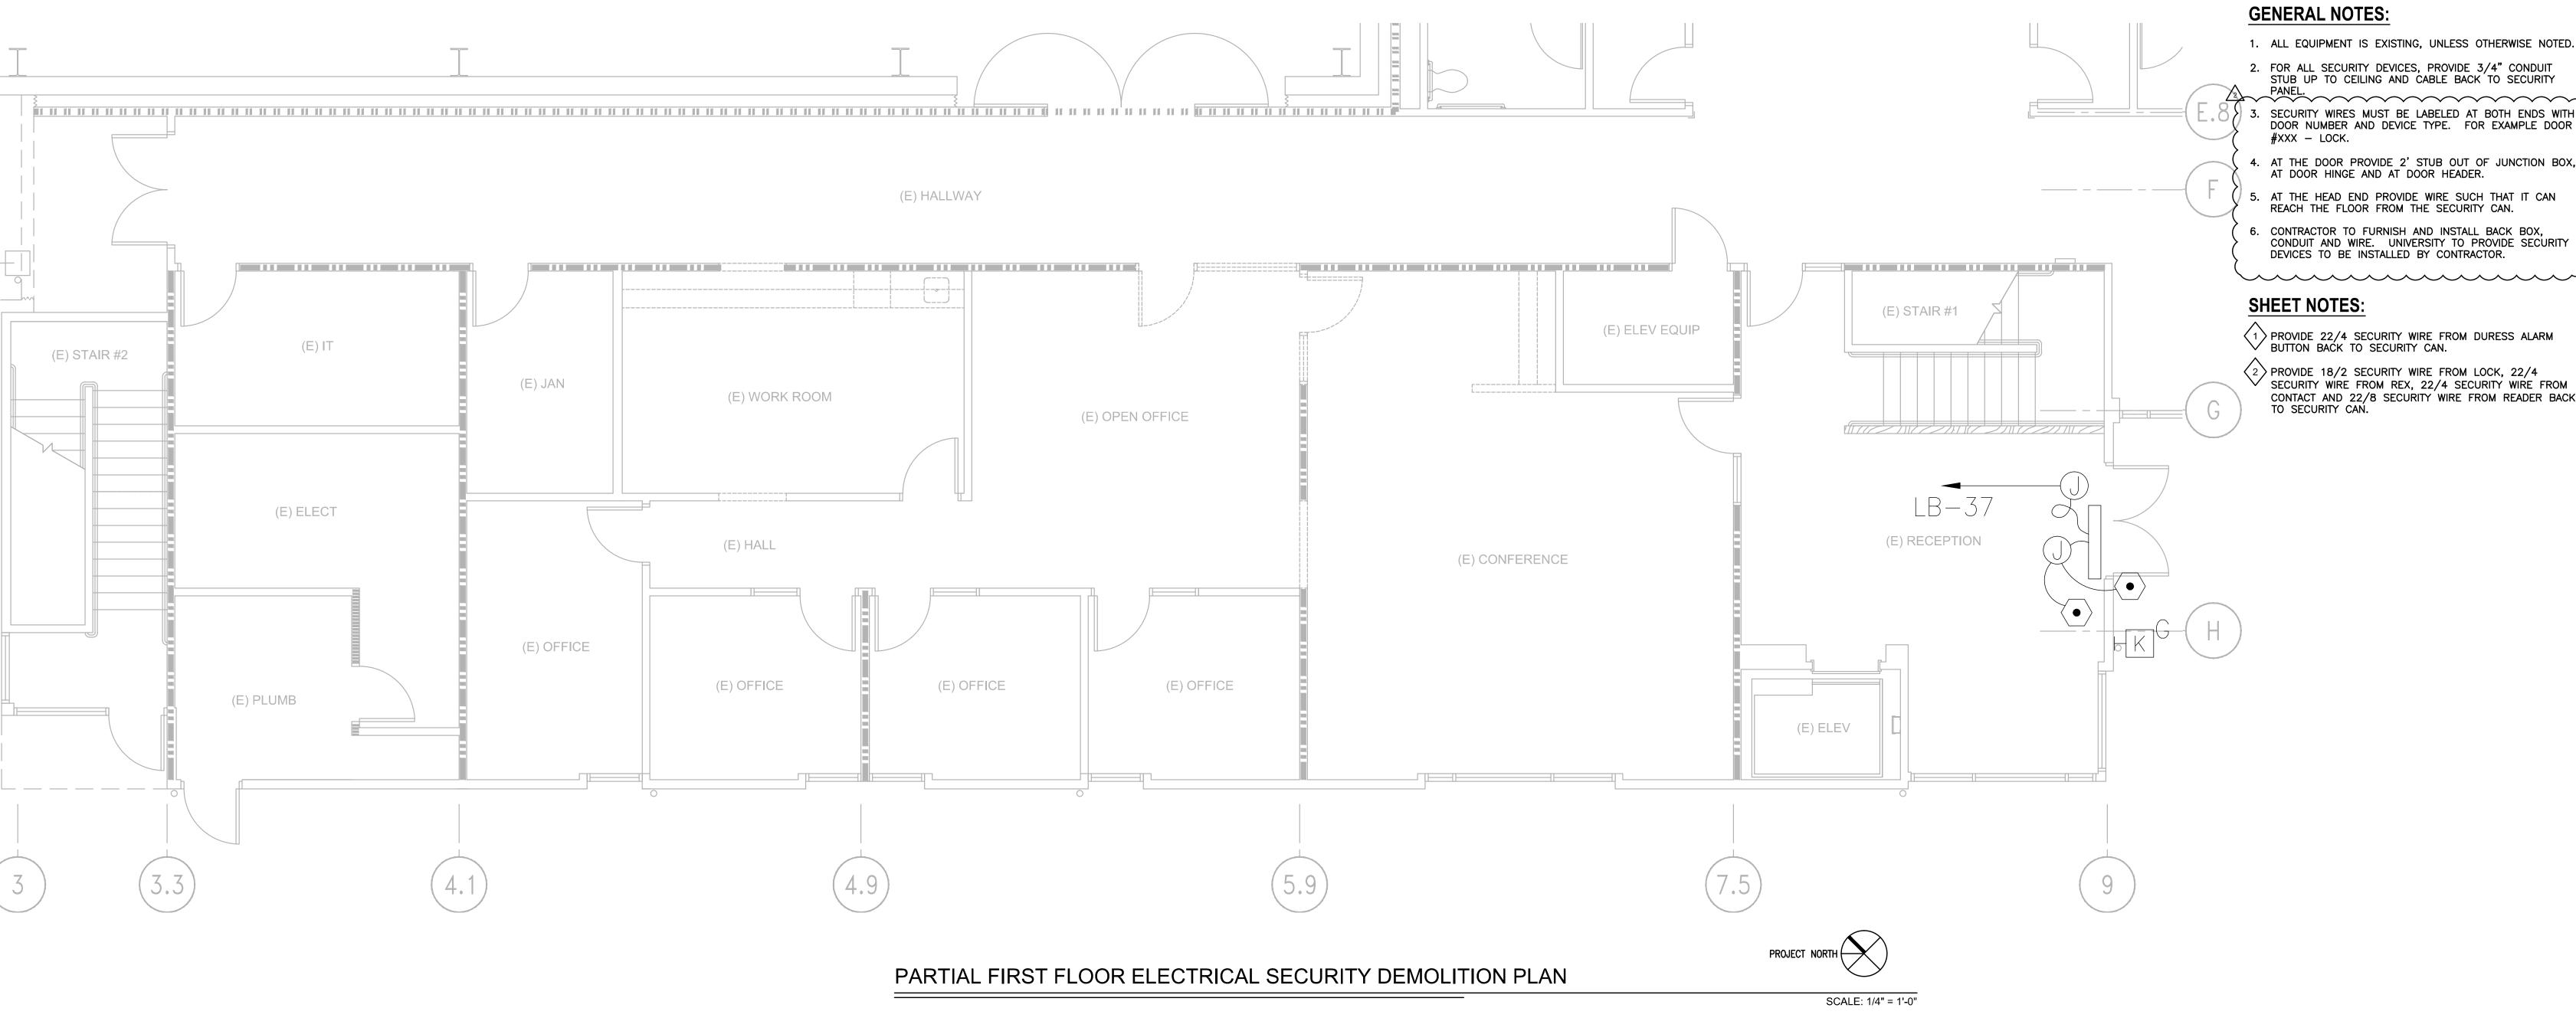

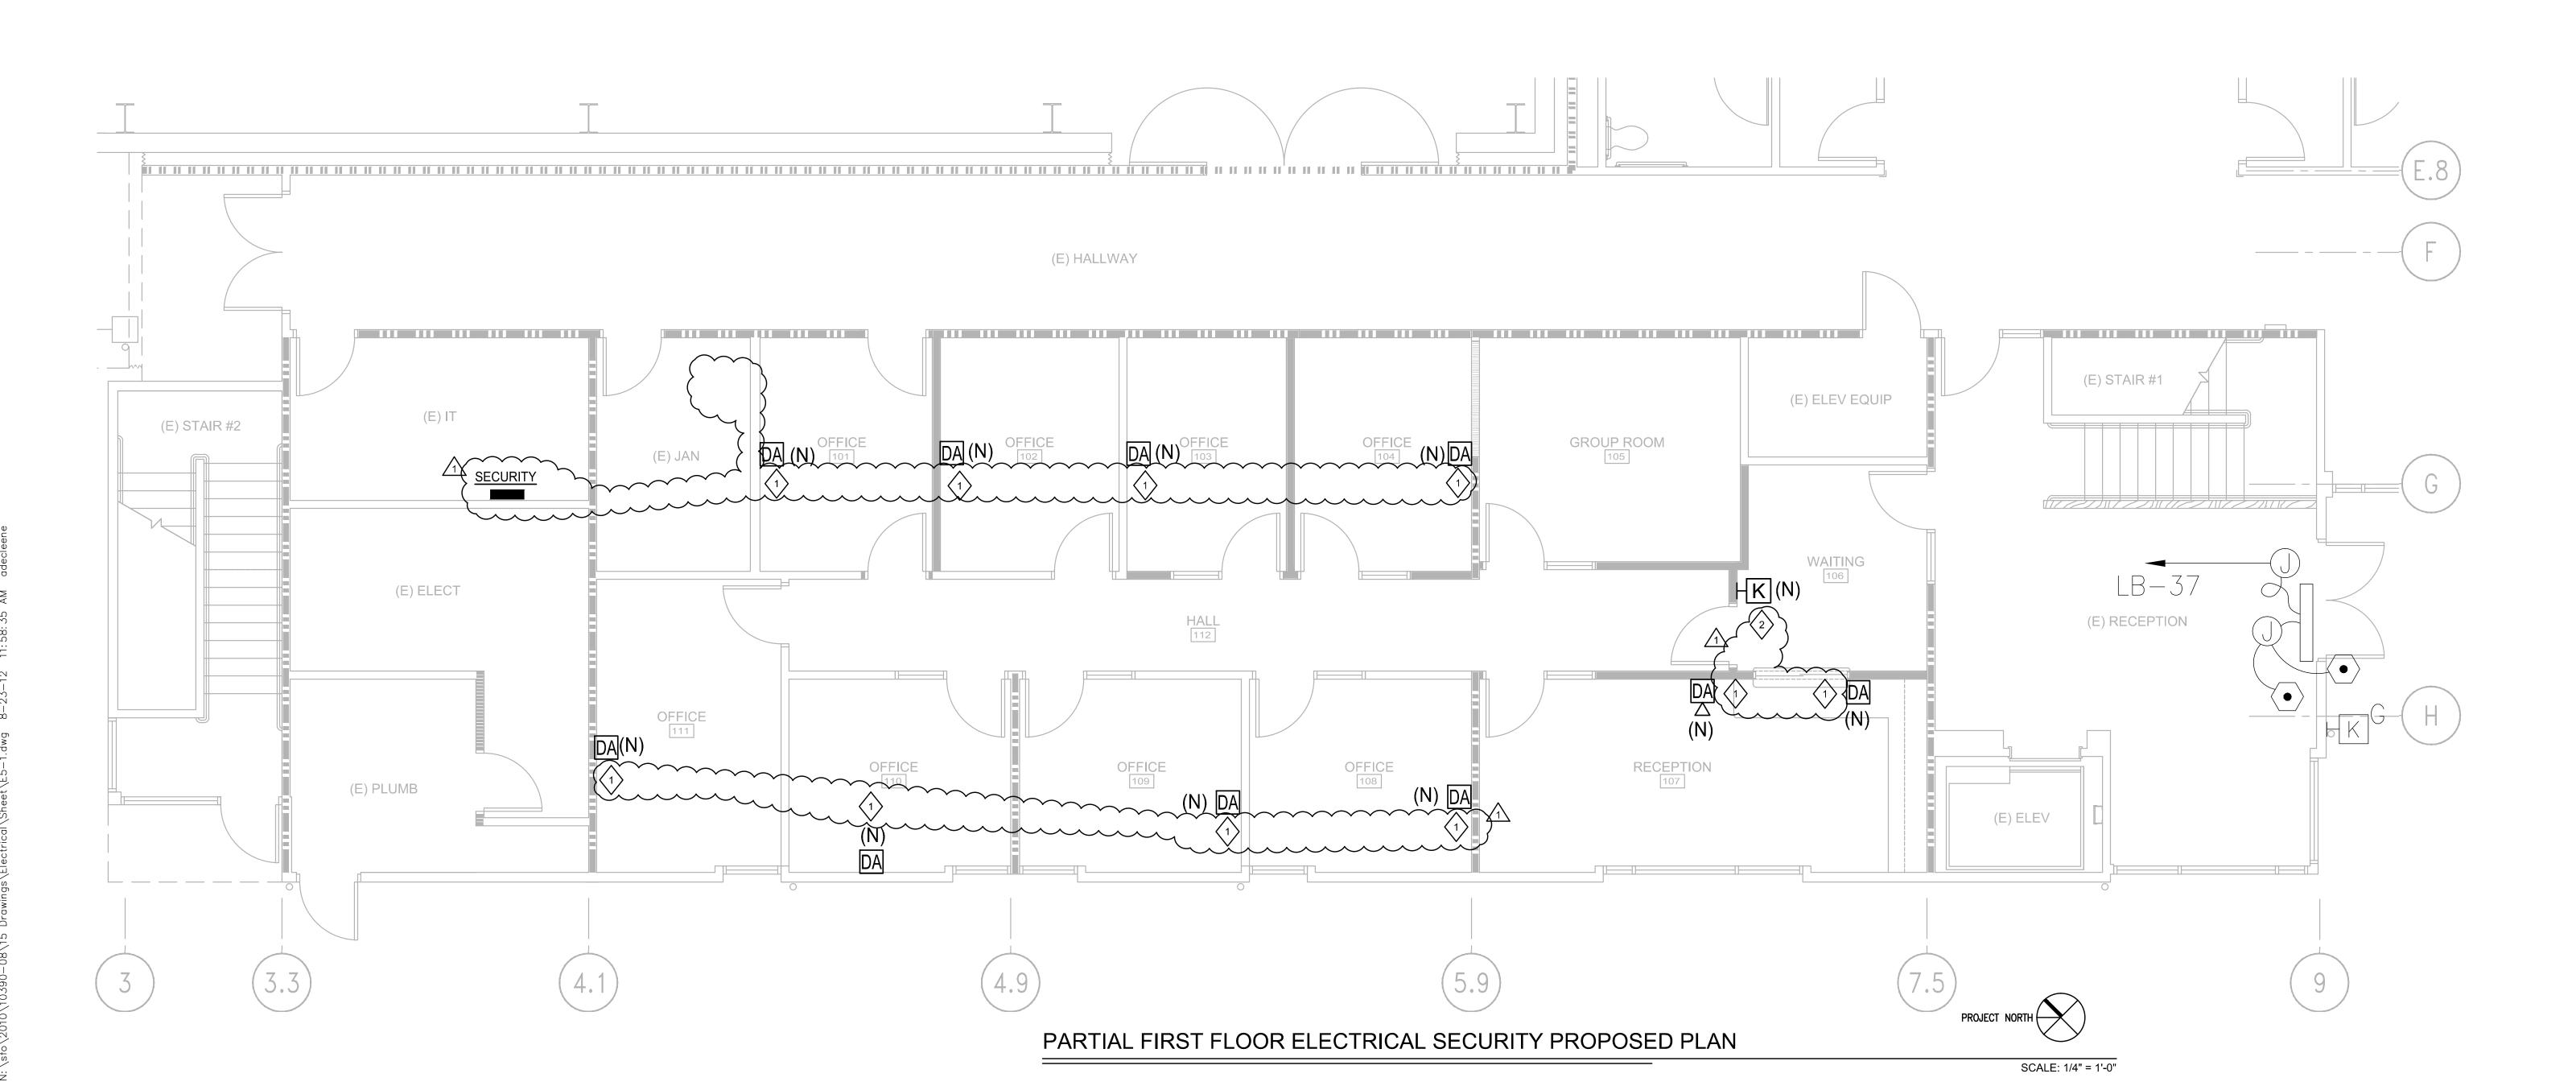

1. ALL EQUIPMENT IS EXISTING, UNLESS OTHERWISE NOTED. 2. FOR ALL SECURITY DEVICES, PROVIDE 3/4" CONDUIT STUB UP TO CEILING AND CABLE BACK TO SECURITY PANEL. 3. SECURITY WIRES MUST BE LABELED AT BOTH ENDS WITH DOOR NUMBER AND DEVICE TYPE. FOR EXAMPLE DOOR

4. AT THE DOOR PROVIDE 2' STUB OUT OF JUNCTION BOX,

AT DOOR HINGE AND AT DOOR HEADER. . AT THE HEAD END PROVIDE WIRE SUCH THAT IT CAN REACH THE FLOOR FROM THE SECURITY CAN.

6. CONTRACTOR TO FURNISH AND INSTALL BACK BOX, CONDUIT AND WIRE. UNIVERSITY TO PROVIDE SECURITY DEVICES TO BE INSTALLED BY CONTRACTOR.

1) PROVIDE 22/4 SECURITY WIRE FROM DURESS ALARM BUTTON BACK TO SECURITY CAN.


2 PROVIDE 18/2 SECURITY WIRE FROM LOCK, 22/4 SECURITY WIRE FROM REX, 22/4 SECURITY WIRE FROM CONTACT AND 22/8 SECURITY WIRE FROM READER BACK TO SECURITY CAŃ.

University of California Merced, California

PROJECT:

WELLNESS CENTER REMODEL

UCM PROJECT #:

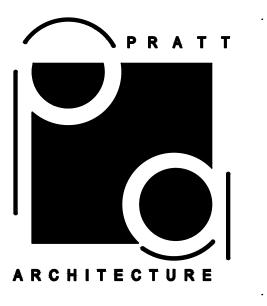

907432

1207 13th STREET, SUITE #6 MODESTO, CA 95354 209.484.2880

CONSULTANT:





AGENCY APPROVALS:

UNIVERSITY OF CALIFORNIA FIRE MARSHAL Approval of this plan does not authorize or approve any omission or deviation from applicable Final approval is subject to field inspection One set of approved plans shall be available on the Project site at all times.

UCM Project #: 907432

IDENTIFICATION STAMP DIV. OF THE STATE ARCHITECT FILE NO. 01-UC MERCED APPL. NO. 01-112735 AC___FLS___SS_

DRAWING STAGE:

DATE:

CONSTRUCTION DOCUMENTS

PLOT DATE: August 23, 2012 ISSUED: JUNE 15, 2012 √1 DSA- BC-1 JULY 9, 2012 BID ADDENDUM AUGUST 6, 2012

PROJECT# 12003


01-112735


SHEET TITLE:

ELECTRICAL SECURITY PLAN LEVEL 1

SHEET NO:

E-5.1

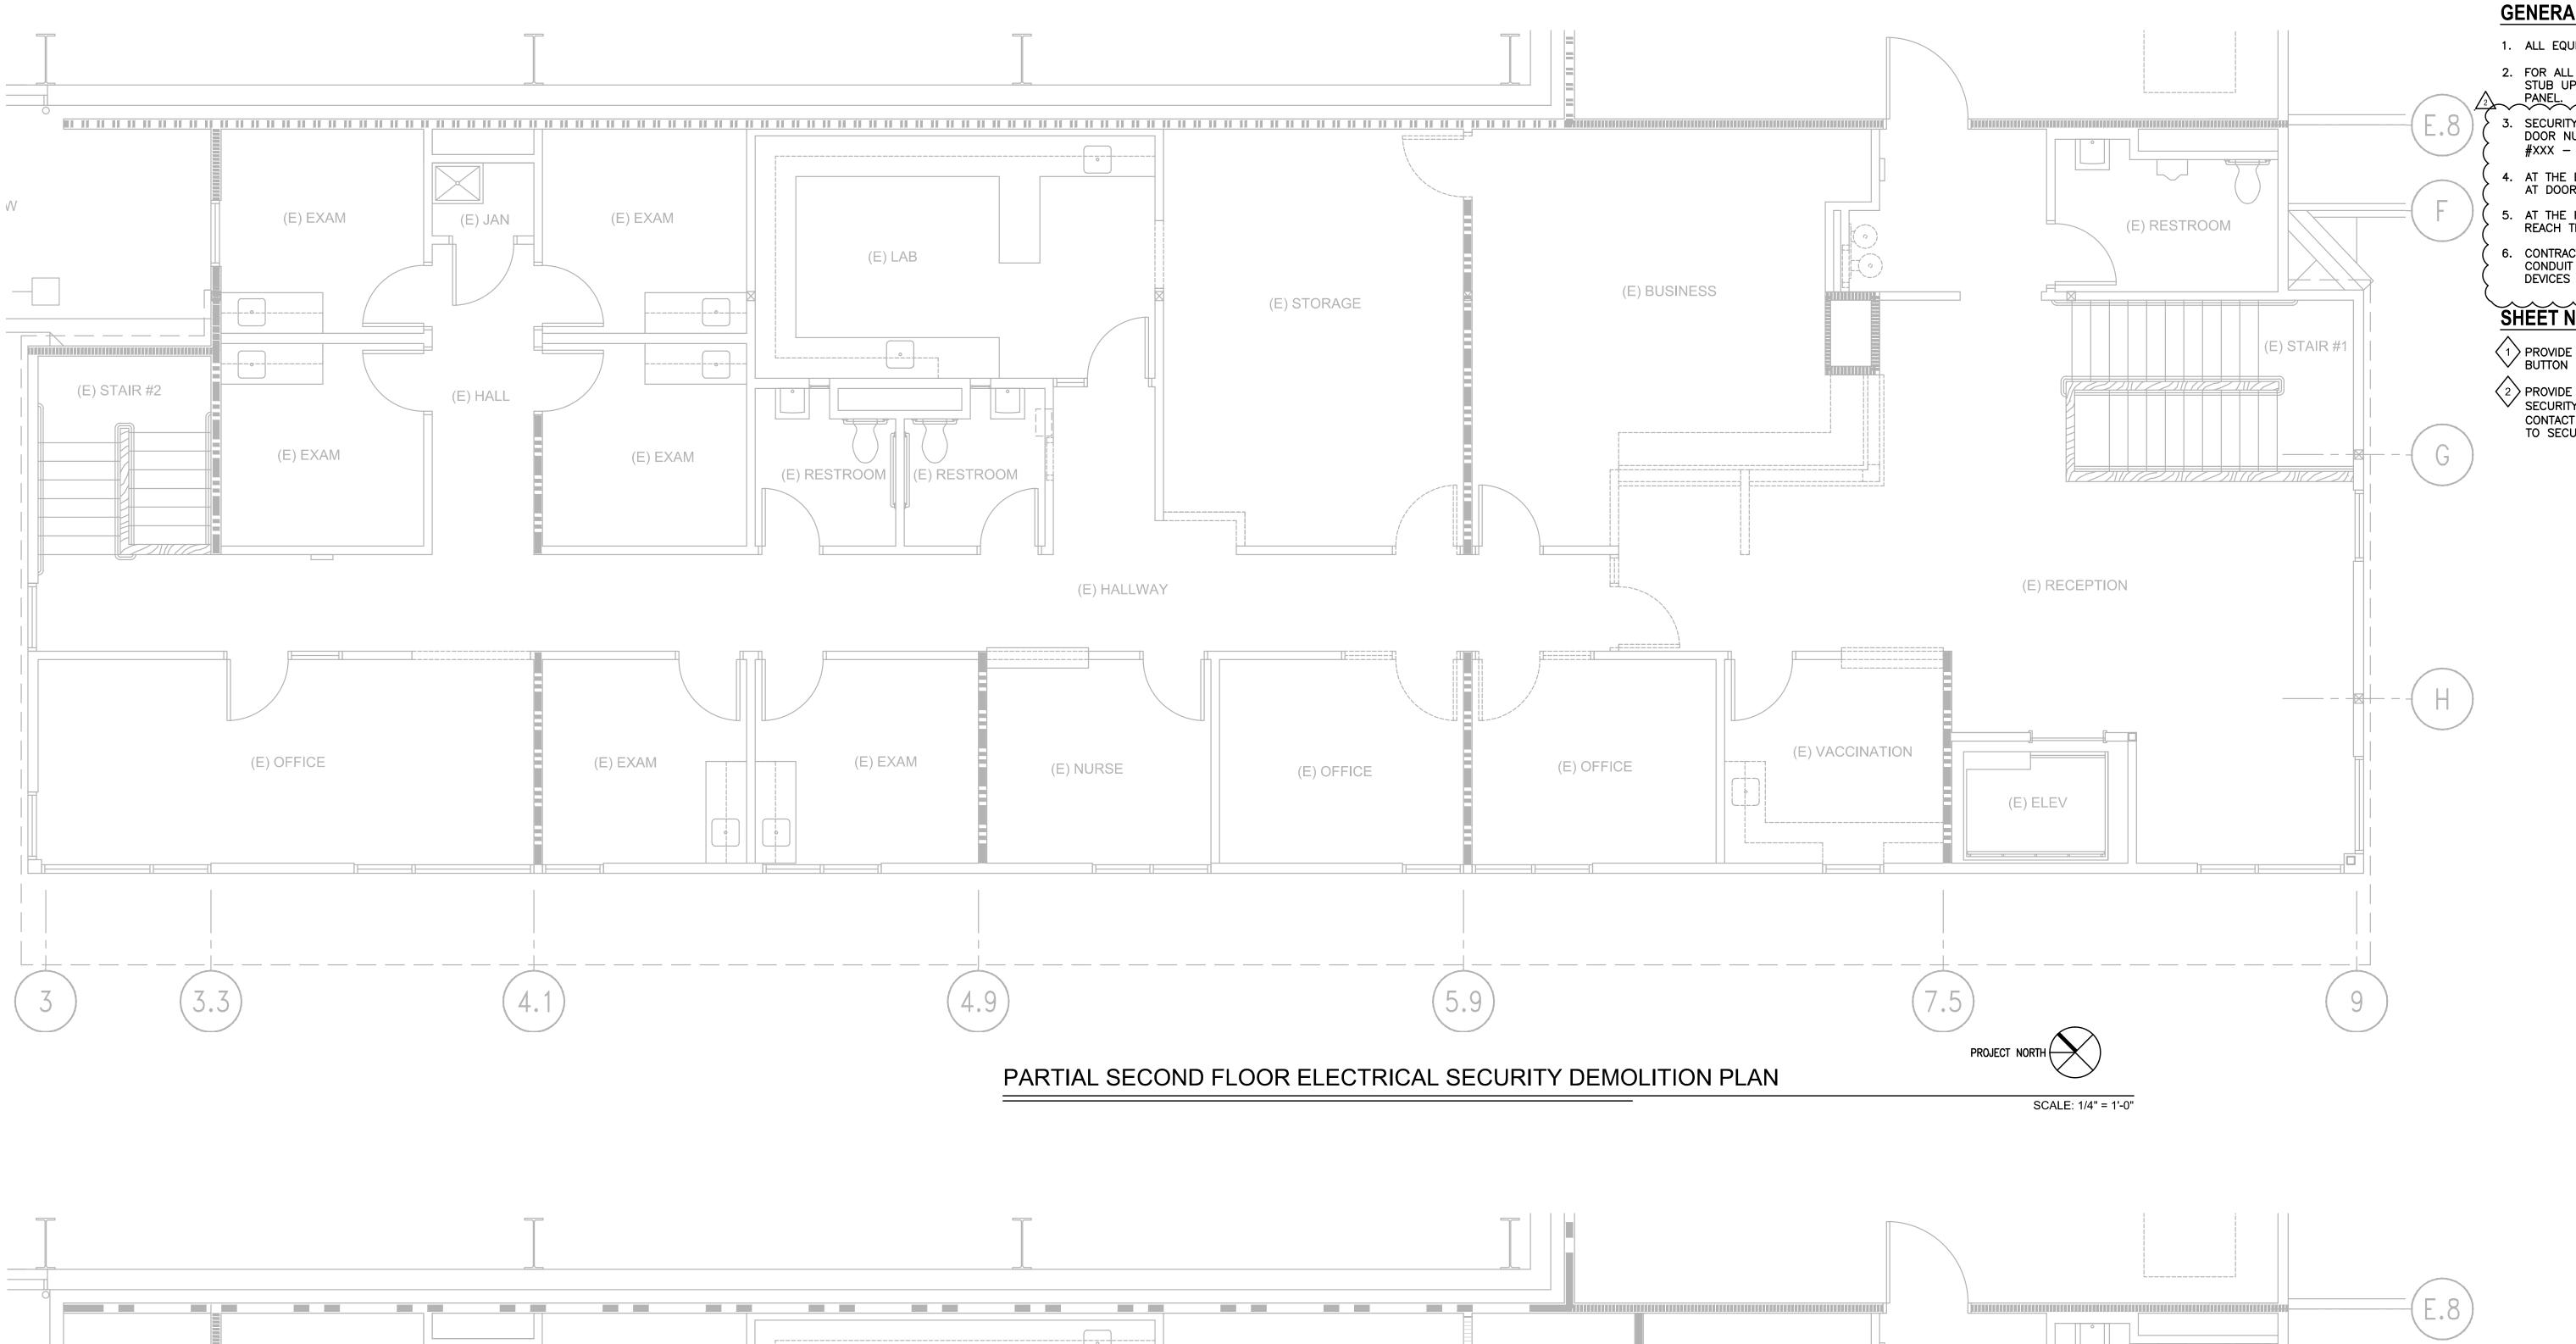

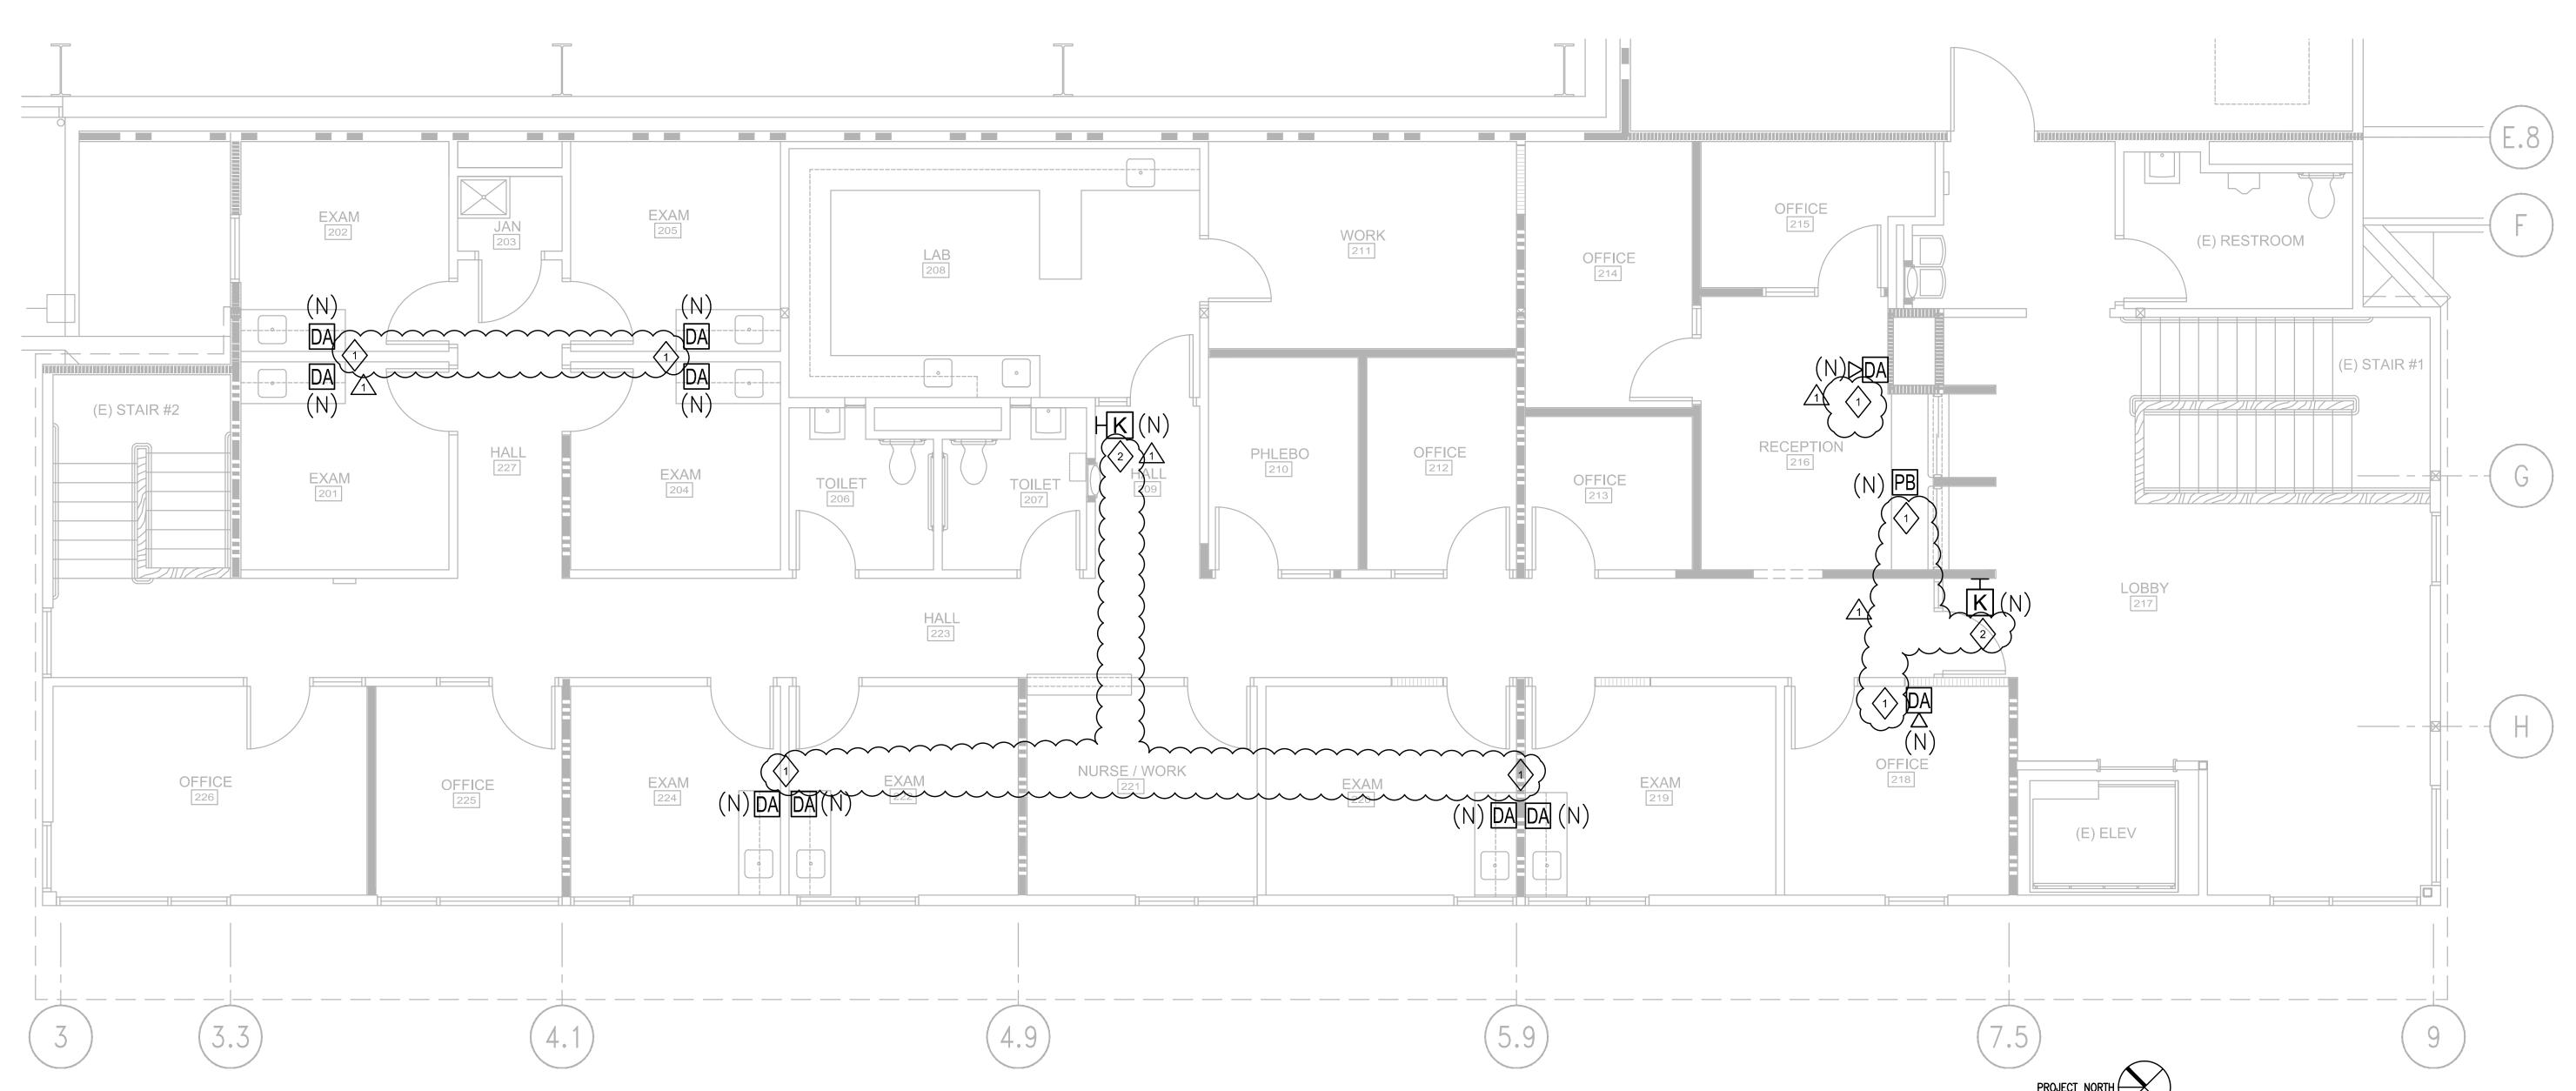

PARTIAL SECOND FLOOR ELECTRICAL SECURITY PROPOSED PLAN

SCALE: 1/4" = 1'-0"

GENERAL NOTES:

- ALL EQUIPMENT IS EXISTING, UNLESS OTHERWISE NOTED.
 FOR ALL SECURITY DEVICES, PROVIDE 3/4" CONDUIT STUB UP TO CEILING AND CABLE BACK TO SECURITY PANEL.
- 3. SECURITY WIRES MUST BE LABELED AT BOTH ENDS WITH DOOR NUMBER AND DEVICE TYPE. FOR EXAMPLE DOOR #XXX LOCK.
- 4. AT THE DOOR PROVIDE 2' STUB OUT OF JUNCTION BOX, AT DOOR HINGE AND AT DOOR HEADER.
- 5. AT THE HEAD END PROVIDE WIRE SUCH THAT IT CAN REACH THE FLOOR FROM THE SECURITY CAN.
- 6. CONTRACTOR TO FURNISH AND INSTALL BACK BOX, CONDUIT AND WIRE. UNIVERSITY TO PROVIDE SECURITY DEVICES TO BE INSTALLED BY CONTRACTOR.

SHEET NOTES:

- PROVIDE 22/4 SECURITY WIRE FROM DURESS ALARM BUTTON BACK TO SECURITY CAN.
- 2 PROVIDE 18/2 SECURITY WIRE FROM LOCK, 22/4 SECURITY WIRE FROM REX, 22/4 SECURITY WIRE FROM CONTACT AND 22/8 SECURITY WIRE FROM READER BACK TO SECURITY CAN.




University of California Merced, California

PROJECT:

WELLNESS CENTER REMODEL

907432


UCM PROJECT #:

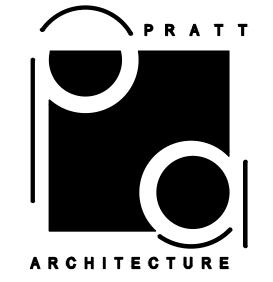

1207 13th STREET, SUITE #6 MODESTO, CA 95354 209.484.2880

CONSULTANT:



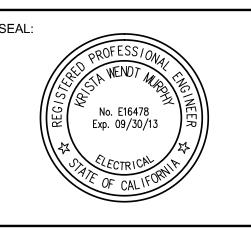

AGENCY APPROVALS:

UNIVERSITY OF CALIFORNIA

MERCED

FIRE MARSHAL

Approval of this plan does not authorize or approve
any omission or deviation from applicable
regulations.

Final approval is subject to field inspection
One set of approved plans shall be available on the
Project site at all times.

IDENTIFICATION STAMP
DIV. OF THE STATE ARCHITECT
FILE NO. 01-UC MERCED
APPL. NO. 01-112735

AC____FLS___SS____

DRAWING STAGE:

DATE:

100%
CONSTRUCTION DOCUMENTS

PLOT DATE: August 23, 2012

ISSUED: JUNE 15, 2012

DSA- BC-1 JULY 9, 2012

BID ADDENDUM AUGUST 6, 2012

PROJECT# 12003

PERMIT #: 01-112735

SHEET TITLE:

ELECTRICAL SECURITY PLAN LEVEL 2

SHEET NO:

E-5.2



Sheet 1 of 3

Office of Statewide Health Planning and Development

ANCHORAGE PRE-APPROVAL

OPA-0697-07

Equipment Manufacturer: GCX Corporation

Equipment Type: 19" GCX Poly Mount with M, VHM & VB Arms

GENERAL NOTES


- 1. FORCES PER ASCE 7-05 SECTION 13.3.1, EQUATIONS 13.3-1, 13.3-2 & 13.3-3, WHERE S $_{DS}$ = 1.93, a_{D} = 2.5, I_{D} = 1.5 & R_{D} = 2.5
- 2. THIS PRE-APPROVAL CONFORMS TO THE 2007 CALIFORNIA BUILDING CODE.
- 3. THE DETAILS IN THIS PRE-APPROVAL MAY BE USED AT ANY HEIGHT AND AT ANY LOCATION IN THE STATE OF CALIFORNIA.
- 4. ALL ANCHOR FORCES SHOWN ON THE DRAWINGS ARE WORKING LOADS (AS OPPOSED TO STRENGTH LEVEL LOADS) AND MAY BE USED FOR ALLOWABLE STRESS DESIGN.
- 5. SHEET METAL SCREWS SHALL BE TEKS SCREWS BY ITW BUILDEX (ICC ESR-1976).
- 6. THIS PRE-APPROVAL COVERS THE ANCHORAGE OF THE UNIT ONLY.

RESPONSIBILITIES OF THE STRUCTURAL ENGINEER OF RECORD

- 7. DESIGN BACKING BARS, STUDS, ETC. WHICH THE UNITS ARE ATTACHED TO AS NOTED ON THE DRAWINGS. THE SEOR SHALL ALSO VERIFY THE ADEQUACY OF THE STRUCTURES (SUCH AS WALLS AND FLOORS) WHICH SUPPORT THE UNITS FOR THE LOADS IMPOSED ON THEM BY THE UNITS AS WELL AS ALL OTHER LOADS.
- 8. PROVIDE ANY SUPPORTING STRUCTURE REQUIRED TO SUPPORT WEIGHTS AND FORCES SHOWN, IN ADDITION TO ALL OTHER LOADS.
- 9. VERIFY THAT THE INSTALLATION IS IN CONFORMANCE WITH THE 2007 CBC AND WITH THE DETAILS SHOWN IN THIS PRE-APPROVAL.

 VERIFY THAT THE ACTUAL EQUIPMENT'S WEIGHT, CG LOCATION, ANCHOR LOCATIONS, ANCHOR DETAILS AND THE MATERIAL AND


 GAGE OF THE UNIT WHERE ATTACHMENTS ARE MADE AGREE WITH THE INFORMATION SHOWN ON THE PRE-APPROVAL DOCUMENTS.

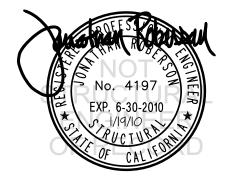



GCX CORPORATION 19" GCX POLY MOUNT with M & VHM ARMS DES. R. LA BRIE JOB NO. 11-0789 DATE 1/19/10 OF 3 SHEETS

SEISMIC ANCHORAGE

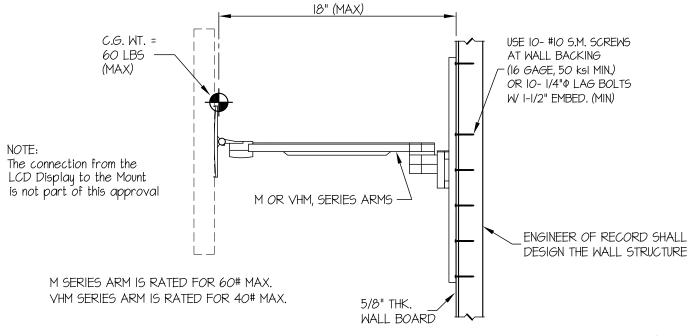

ELEVATION


T_{MAX} = 74 LBS/BOLT V_{MAX} = 98 LBS/BOLT

NOTES:


- 1. ANCHORAGE DESIGN PER 2007 CALIFORNIA BUILDING CODE SECTION 1613A AND ASCE 7-05 SECTIONS 12 AND 13. ALLOWABLE STRESS DESIGN IS USED. HORIZONTAL FORCE (E_h) = 2.43 W_p (S_{DS} = 1.93, a_p = 2.5, I_p = 1.5, R_p = 2.5) VERTICAL FORCE (E_v) = 0.27 W_p
- 2. CENTER OF GRAVITY (C.G.) WEIGHT IS A MAXIMUM. THIS PRE-APPROVAL ENCOMPASSES ALL WEIGHTS UP TO THE MAXIMUM WEIGHT SHOWN.
- 3. ENGINEER OF RECORD FOR THE BUILDING SHALL PROVIDE SUPPORT STRUCTURE DESIGNED TO SUPPORT WEIGHTS AND FORCES SHOWN, IN ADDITION TO ALL OTHER LOADS.
- 4. SEE GENERAL NOTES: SHEET 1





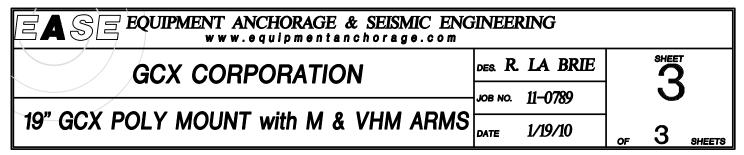

SEISMIC ANCHORAGE

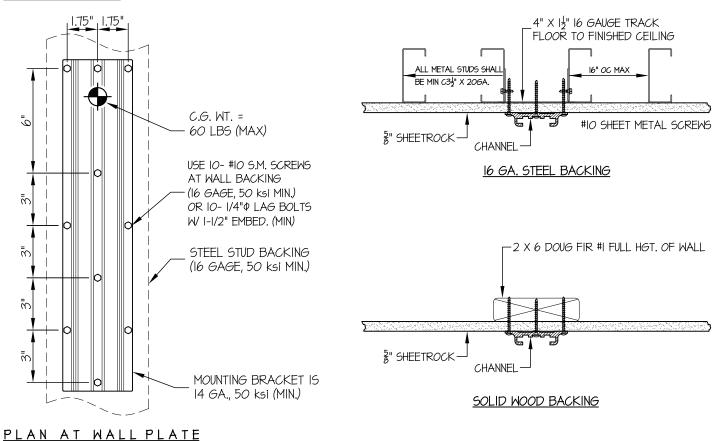







Sheet 1 of 3

Office of Statewide Health Planning and Development

ANCHORAGE PRE-APPROVAL

OPA-1665-07

Equipment Manufacturer: GCX Corporation

Equipment Type: VHC Wall Mount

GENERAL NOTES


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- 2. THIS PRE-APPROVAL CONFORMS TO THE 2007 CALIFORNIA BUILDING CODE.
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- 4. ALL ANCHOR FORCES SHOWN ON THE DRAWINGS ARE WORKING LOADS (AS OPPOSED TO STRENGTH LEVEL LOADS) AND MAY BE USED FOR ALLOWABLE STRESS DESIGN.
- 5. SHEET METAL SCREWS SHALL BE TEKS SCREWS BY ITW BUILDEX (ICC ESR-1976).
- 6. PER CAN 2-1708A.5, THIS UNIT DOES NOT REQUIRE "SPECIAL SEISMIC CERTIFICATION".


RESPONSIBILITIES OF THE STRUCTURAL ENGINEER OF RECORD

- 7. DESIGN BACKING BARS, STUDS, ETC. WHICH THE UNITS ARE ATTACHED TO AS NOTED ON THE DRAWINGS.
 THE SEOR SHALL ALSO VERIFY THE ADEQUACY OF THE STRUCTURES (SUCH AS WALLS AND FLOORS)
 WHICH SUPPORT THE UNITS FOR THE LOADS IMPOSED ON THEM BY THE UNITS AS WELL AS ALL OTHER LOADS.
- 8. PROVIDE ANY SUPPORTING STRUCTURE REQUIRED TO SUPPORT WEIGHTS AND FORCES SHOWN, IN ADDITION TO ALL OTHER LOADS.
- 9. VERIFY THAT THE INSTALLATION IS IN CONFORMANCE WITH THE 2007 CBC AND WITH THE DETAILS SHOWN IN THIS PRE-APPROVAL. VERIFY THAT THE ACTUAL EQUIPMENT'S WEIGHT, CG LOCATION, ANCHOR LOCATIONS, ANCHOR DETAILS AND THE MATERIAL AND GAGE OF THE UNIT WHERE ATTACHMENTS ARE MADE AGREE WITH THE INFORMATION SHOWN ON THE PRE-APPROVAL DOCUMENTS.





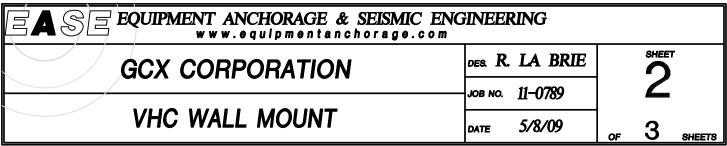

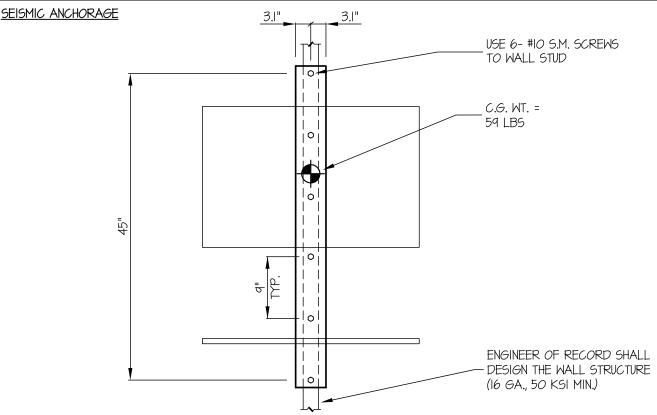


NOTES:

PLAN AT WALL PLATE


1. ANCHORAGE DESIGN PER 2007 CALIFORNIA BUILDING CODE - SECTION 1613A AND ASCE 7-05 SECTIONS 12 AND 13. ALLOWABLE STRESS DESIGN IS USED. HORIZONTAL FORCE (E_h) = 2.43 W_p (S_{DS} = 1.93, a_p = 2.5, I_p = 1.5, R_p = 2.5) VERTICAL FORCE (E_v) = 0.27 W_p

T MAX = 125 LBS/SCREW VMAX = 60 LBS/SCREW

- 2. CENTER OF GRAVITY (C.G.) WEIGHT IS A MAXIMUM. THIS PRE-APPROVAL ENCOMPASSES ALL WEIGHTS UP TO THE MAXIMUM WEIGHT SHOWN.
- 3. ENGINEER OF RECORD FOR THE BUILDING SHALL PROVIDE SUPPORT STRUCTURE DESIGNED TO SUPPORT WEIGHTS AND FORCES SHOWN, IN ADDITION TO ALL OTHER LOADS.

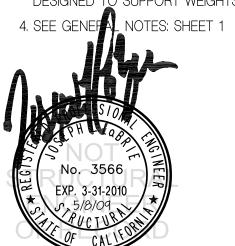



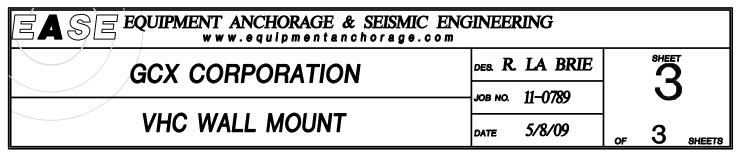

SEISMIC ANCHORAGE

